November 14, 2019 Agenda Item No. 5

**SUBJECT:** Pickup Residence (PA2019-051)

Coastal Development Permit No. CD2019-011

SITE LOCATION: 23 Harbor Island

**APPLICANT:** Ritner Group, Inc.

**OWNER:** Mr. and Mrs. Todd Pickup

**PLANNER:** Chelsea Crager, Associate Planner

949-644-3227, ccrager@newportbeachca.gov

#### **LAND USE AND ZONING**

• **General Plan:** RS-D (Single-Unit Residential Detached)

• **Zoning District**: R-1 (Single-Unit Residential)

Coastal Land Use Category: RSD-A (Single Unit Residential Detached) (0.0-5.9 DU/AC)

Coastal Zoning District: R-1 (Single-Unit Residential)

#### **PROJECT SUMMARY**

A coastal development permit (CDP) permit to demolish an existing single-family residence and construct a new two-story, 6,357-square-foot, single-family residence with an 815-square-foot garage. The project includes hardscape, drainage, and landscaping improvements. The project also includes accessory structures and a reinforced bulkhead with cap for coastal hazards protection located in the Harbor Island Tidelands. The proposed residence complies with all applicable development standards including height, setbacks, and floor area limits. No deviations are requested.

The project includes improvements within the Harbor Island Tidelands, including accessory structures and the reinforcement and capping of the existing bulkhead, which are within the California Coastal Commission's coastal permit jurisdiction boundary and therefore require their review. This Coastal Development Permit is intended to cover portions of the project within the City's permit authority as designated in the Local Coastal Program (Title 21 of the Newport Beach Municipal Code).

#### **RECOMMENDATION**

- 1) Conduct a public hearing;
- Find this project exempt from the California Environmental Quality Act (CEQA) pursuant to Section 15303 under Class 3 (New Construction or Conversion of Small Structures) because it has no potential to have a significant effect on the environment; and
- 3) Adopt Draft Zoning Administrator Resolution No. \_ approving Coastal Development Permit No. CD2019-011 (Attachment No. ZA 1).

#### **DISCUSSION**

Land Use and Development Standards

- The subject property is located in the R-1 Coastal Zoning District, which provides for single-unit residential development and is consistent with the City's Coastal Land Use Plan, General Plan, and Zoning Code. A coastal development permit is required and the property is not eligible for a waiver for de minimis development because the property is located in the Coastal Commission Appeal Area.
- The property currently consists of a legal lot developed with a single-family residence.
  The neighborhood is predominantly developed with two-story single-family
  residences. The proposed design, bulk, and scale of the development is consistent
  with the existing neighborhood pattern of development and expected future
  development consistent with applicable development standards.
- The proposed single-family dwelling and accessory structures conform to all applicable development standards, including floor area limit, setbacks, height, and off-street parking as evidenced by the project plans and illustrated in Table 1 below.

Table 1 – Development Standards				
Development Standard	Standard	Proposed		
Setbacks (min.)				
Front (island interior)	15 feet	26 feet		
Front (water)	15 feet	15 feet		
Sides	4 feet	4 feet		
Allowable Floor Area (max.)	10,416 square feet	6,357 square feet		
Allowable 3 <sup>rd</sup> Floor Area (max.)	781 square feet	0 square feet		
Open Space (min.)	781 square feet	1,744 square feet		
Parking (min.)	3-car garage	3-car garage		
Height (max.)	24-foot flat roof	29-foot sloped roof		
	29-foot sloped roof			

#### Hazards

- The property fronts the Newport Bay and is a private waterfront parcel. The project site is protected by an existing seawall with the top of the bulkhead at elevation 8.55 feet North American Vertical Datum of 1988 (NAVD 88). The existing bulkhead does not have noticeable signs of distress, however based on the bulkhead condition report, it is required to be repaired and raised. The site is also vulnerable to flooding from the adjacent street ends and other low-lying properties that will need to be protected in the future. The project includes a proposal to reinforce the existing wall and add a cap that will bring the height to 10.6 feet (NAVD 88). This portion of the project is located within the California Coastal Commission's permit jurisdiction and therefore required their review. No development is proposed bayward of the existing seawall.
- A Coastal Hazards Report and Sea Level Rise Analysis was prepared by William Simpson and Associates, Inc. dated April 17, 2019, for the project. The current maximum bay water elevation is 7.7 feet (NAVD 88). According to the report, the estimated sea level rise at the site appears to be between 1.3 and 5.4 feet over the next 75 years utilizing different probabilistic scenarios, accounting for bay water levels rising in the range of 9 feet to 13.1 feet NAVD 88. The Newport Beach City Council approved the use of the high estimate of the "low risk aversion" scenario, which is 3.2 feet by the year 2100, or 2.9 feet by 2094. Therefore, the sea level is estimated to likely reach approximately 10.6 feet NAVD 88 over the next 75 years (i.e. the life of the structure). Once the existing seawall/bulkhead is raised per the report's recommendations, flooding, wave runup, and erosion will not significantly impact this property over the proposed 75-year economic life of the development. The report also identifies that there is a 0.5 percent chance (medium-high risk aversion scenario) that sea level rise (SLR) would be greater than 2.9 feet around the year 2070 and could as high as 13.1 feet NAVD 88 by the year 2100. If future SLR is greater than the likely estimate of the "low risk aversion" scenario by 2094 (10.6 feet NAVD 88), then the bulkhead can be raised without further bayward encroachment.
- The finished floor elevation of the proposed single-family residence is 13.2 feet (NAVD 88), which complies with the minimum 9.00-foot (NAVD 88) elevation standard. The Coastal Hazard Report concludes that the bay water elevation (currently 7.7 feet NAVD 88) will not exceed the proposed finished floor of the single-family residence at elevation 13.2 feet (NAVD 88) for the anticipated 75-year life of the structure.
- Pursuant to Newport Beach Municipal Code (NBMC) Section 21.30.030(C)(3)(i)(iv), the property owner will be required to enter into an agreement with the City waiving any potential right to protection to address situations in the future in which the development is threatened with damage or destruction by coastal hazards (e.g.,

waves, erosion, and sea level rise). The property owner will also be required to acknowledge any hazards present at the site and unconditionally waive any claim to damage or liability against the decision authority, consistent with NBMC Section 21.30.015(D)(3)(c). Both requirements are included as conditions of approval that will need to be satisfied prior to final building inspection, and prior to the issuance of building permits, respectively.

• The property is located in an area known for the potential of seismic activity and liquefaction. All projects are required to comply with the California Building Code (CBC) and Building Division standards and policies. Geotechnical investigations specifically addressing liquefaction are required to be reviewed and approved prior to the issuance of a building permit. Permit issuance is also contingent on the inclusion of design mitigation identified in the investigations. Construction plans are reviewed for compliance with approved investigations and CBC prior to building permit issuance.

#### Water Quality

- The property fronts the Newport Bay. Pursuant to NBMC <u>Section 21.35.030</u> (<u>Construction Pollution Prevention Plan</u>), a Construction Pollution Prevention Plan (CPPP) is required to implement temporary Best Management Practices (BMPs) during construction to minimize erosion and sedimentation and to minimize pollution of runoff and coastal waters derived from construction chemicals and materials. A CPPP has been prepared and included in the plan sets for review and approval prior to the issuance of construction permits. Construction plans and activities will be required to adhere to the approved CPPP.
- Pursuant to NBMC <u>Section 21.35.050 (Water Quality and Hydrology Plan)</u>, because of the site's proximity to the water and because the development contains more than 75 percent of impervious surface area, a Water Quality and Hydrology Plan (WQHP/WQMP) was prepared by Toal Engineering, Inc., dated February 7, 2019. The final WQHP/WQMP will be required to be reviewed and approved by the City's Engineer Geologist prior to building permit issuance. The WQHP/WQMP includes a polluted runoff and hydrologic site characterization, treatment control BMPs, use of a low-impact development approach and bioretention system to retain the design storm runoff volume on-site, and documentation of the expected effectiveness of the proposed BMPs. Construction plans will be required to comply with the approved WQHP/WQMP prior to the issuance of building permits.
- The project design addresses water quality with a construction erosion control plan and a post-construction drainage system that includes drainage and percolation features designed to retain dry weather runoff and minor rain event runoff on-site. Any water not retained on-site is directed to the City's storm drain system.

#### Public Access and Views

- The project site is located on a privately gated island between the nearest public road and the sea or shoreline. Implementation Plan Section 21.30A.040 requires that the provision of public access bear a reasonable relationship between the requirement and the project's impact, and be proportional to the impact. In this case, the project replaces an existing single-family residence located on an R-1 lot with a new single-family residence. Therefore, the project does not involve a change in land use, density or intensity that will result in increased demand on public access and recreation opportunities. Furthermore, the project is designed and sited (appropriate height, setbacks, etc.) so as not to block or impede existing public access opportunities.
- The project site is not located adjacent to a coastal view road, public access way, or coastal viewpoint as identified in the Coastal Land Use Plan. The nearest coastal viewpoint is located at the end of Harbor Island Drive and is not visible from the site. The proposed single-family residence complies with all applicable Local Coastal Program (LCP) development standards and maintains a building envelope consistent with the existing neighborhood pattern of development. The front setback along the harbor is 15 feet and only allows improvements with a maximum height of 42 inches. Additionally, the project does not contain any unique features that could degrade the visual quality of the coastal zone.
- Vertical access to the harbor is available at the Balboa Basin, approximately 2,000 feet east of the property. Vertical and lateral access to the beach and harbor is also available at street ends throughout Balboa Island, approximately 1,300 feet southeast of the property. The project does not include any features that would obstruct access along these routes.

#### **ENVIRONMENTAL REVIEW**

This project is exempt from the California Environmental Quality Act (CEQA) pursuant to Section 15303 under Class 3 (New Construction or Conversion of Small Structures) of the CEQA Guidelines, California Code of Regulations, Title 14, Chapter 3, because it has no potential to have a significant effect on the environment.

Class 3 exempts the demolition of up to three single-family residences and additions of up to 10,000 square feet to existing structures. The proposed project consists of the demolition of one single-family residence and the construction of a new 6,357-square-foot single-family residence.

#### **PUBLIC NOTICE**

Notice of this public hearing was published in the Daily Pilot, mailed to all owners and residential occupants of property within 300 feet of the boundaries of the site (excluding intervening rights-of-way and waterways), including the applicant, and posted on the subject property at least 10 days before the scheduled hearing, consistent with the provisions of the Municipal Code. Additionally, the item appeared on the agenda for this meeting, which was posted at City Hall and on the City website.

#### **APPEAL PERIOD:**

This action shall become final and effective 14 days following the date the Resolution is adopted unless within such time an appeal or call for review is filed with the Community Development Director in accordance with the provisions of Title 21 (Local Coastal Implementation Plan) of the Newport Beach Municipal Code. Final action taken by the City may be appealed to the Coastal Commission in compliance with Section 21.64.035 of the City's certified LCP and Title 14 California Code of Regulations, Sections 13111 through 13120, and Section 30603 of the Coastal Act. For additional information on filing an appeal, contact the Planning Division at 949-644-3200.

Prepared by:

Chelsea Crager

Associate Planner

GBR/cc

Attachments: ZA 1 Draft Resolution

ZA 2 Vicinity Map ZA 3 Project Plans

# Attachment No. ZA 1

**Draft Resolution** 

#### **RESOLUTION NO. ZA2019-###**

A RESOLUTION OF THE ZONING ADMINISTRATOR OF THE CITY OF NEWPORT BEACH APPROVING COASTAL DEVELOPMENT PERMIT NO. CD2019-011 TO DEMOLISH AN EXISTING SINGLE-FAMILY RESIDENCE AND CONSTRUCT A NEW TWO-STORY, SINGLE-FAMILY RESIDENCE INCLUDING AN ATTACHED GARAGE LOCATED AT 23 HARBOR ISLAND (PA2019-051)

THE ZONING ADMINISTRATOR OF THE CITY OF NEWPORT BEACH HEREBY FINDS AS FOLLOWS:

#### SECTION 1. STATEMENT OF FACTS.

- 1. An application was filed by Ritner Group, Inc., with respect to property located at 23 Harbor Island, requesting approval of a coastal development permit.
- 2. The lot at 23 Harbor Island is legally described as Lot 23 of Tract 802.
- 3. The applicant requests a coastal development permit to demolish an existing single-family residence and construct a new two-story, 6,357-square-foot, single-family residence with an 815-square-foot garage. The project includes hardscape, drainage, landscaping improvements, and accessory structures. The project also includes accessory structures and a reinforced bulkhead with cap for coastal hazards protection located in the Harbor Island Tidelands. The proposed residence complies with all applicable development standards including height, setbacks, and floor area limits. No deviations are requested. The portions of the project within the Harbor Island Tidelands are within the California Coastal Commission's coastal permit jurisdiction boundary and therefore require their review.
- 4. The project includes improvements with the Harbor Island Tidelands, which are within the California Coastal Commission's permit jurisdiction. This Coastal Development Permit is intended to cover portions of the project within the City's permit authority as designated in the certified Local Coastal Program (LCP) (Title 21 of the Newport Beach Municpal Code).
- 5. The subject property is designated RS-D (Single-Unit Residential Detached) by the General Plan Land Use Element and is located within the R-1 (Single-Unit Residential) Zoning District.
- 6. The subject property is located within the coastal zone. The Coastal Land Use Plan category is RSD-A (Single Unit Residential Detached) (0.0-5.9 DU/AC) and it is located within the R-1 (Single-Unit Residential) Coastal Zone District.
- 7. A public hearing was held on November 14, 2019, in the Corona del Mar Conference Room (Bay E-1st Floor) at 100 Civic Center Drive, Newport Beach. A notice of time, place and purpose of the hearing was given in accordance with the Newport Beach Municipal

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Code. Evidence, both written and oral, was presented to, and considered by, the Zoning Administrator at this hearing.

#### SECTION 2. CALIFORNIA ENVIRONMENTAL QUALITY ACT DETERMINATION.

- 1. This project is categorically exempt pursuant to Title 14 of the California Code of Regulations Section 15303, Article 19 of Chapter 3, Guidelines for Implementation of the California Environmental Quality Act (CEQA) under Class 3 (New Construction or Conversion of Small Structures), because it has no potential to have a significant effect on the environment.
- Class 3 exempts the demolition of up to three single-family residences and additions of up to 10,000 square feet to existing structures. The proposed project consists of the demolition of one single-family residence and the construction of a new 6,357-squarefoot single-family residence.
- 3. The exceptions to this categorical exemption under Section 15300.2 are not applicable. The project location does not impact an environmental resource of hazardous or critical concern, does not result in cumulative impacts, does not have a significant effect on the environment due to unusual circumstances, does not damage scenic resources within a state scenic highway, is not a hazardous waste site, and is not identified as a historical resource.

#### SECTION 3. REQUIRED FINDINGS.

In accordance with Section 21.52.015 (Coastal Development Permits, Findings and Decision) of the Newport Beach Municipal Code (NBMC), the following findings and facts in support of such findings are set forth:

#### Finding:

A. Conforms to all applicable sections of the certified Local Coastal Program.

#### Facts in Support of Finding:

- 1. The proposed development complies with applicable residential development standards including, but not limited to, floor area limitation, setbacks, height, and parking.
  - a. The maximum floor area limitation is 10,416 square feet and the proposed floor area is 6,357 square feet.
  - b. The proposed development provides the minimum required setbacks, which are 15 feet along the front property line abutting the interior of Harbor Island, 4 feet along each side property line and 15 feet along the front property line on the waterfront, adjacent to the Harbor Island Tidelands.
  - c. The highest guardrail is less than 24 feet from established grade (12.63 feet North American Vertical Datum of 1988 [NAVD 88]) and the highest ridge is no more than

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- 29 feet from established grade, which comply with the maximum height requirements.
- d. The project includes garage parking for a total of three vehicles, complying with the minimum three-car garage parking requirement for single-family residences with more than 4,000 square feet of habitable floor area.
- 2. The neighborhood is predominantly developed with two-story, single-family residences. The proposed design, bulk, and scale of the development is consistent with the existing neighborhood pattern of development.
- 3. The property fronts the Newport Bay and is a private waterfront parcel. The project site is protected by an existing seawall with the top of the bulkhead at elevation 8.55 feet (NAVD 88). The existing bulkhead does not have noticeable signs of distress, however it is recommended to be reinforced and raised. The site is also vulnerable to flooding from the adjacent street ends and other low-lying properties that will need to be protected in the future. The project proposes to reinforce the existing wall and add a cap that will bring the height to 10.6 feet (NAVD 88). No development is proposed bayward of the existing seawall.
- 4. A Coastal Hazards Report and Sea Level Rise Analysis was prepared by William Simpson and Associates, Inc. dated April 17, 2019, for the project. The current maximum bay water elevation is 7.7 feet NAVD 88. According to the report, the estimated sea level rise at the site appears to be between 1.3 and 5.4 feet over the next 75 years utilizing different probabilistic scenarios, accounting for bay water levels rising in the range of 9 feet to 13.1 feet NAVD88. The Newport Beach City Council approved the use of the high estimate of the "low risk aversion" scenario, which is 3.2 feet by the year 2100, or 2.9 feet by 2094. Therefore, the sea level is estimated to likely reach approximately 10.6 feet NAVD 88 over the next 75 years (i.e. the life of the structure). Once the existing seawall/bulkhead is raised per the report's recommendations, flooding, wave runup, and erosion will not significantly impact this property over the proposed 75-year economic life of the development. The report also identifies that there is a 0.5 percent chance (medium-high risk aversion scenario) that sea level rise (SLR) would be greater than 2.9 feet around the year 2070 and could as high as 13.1 feet NAVD 88 by the year 2100. If future SLR is greater than the likely estimate of the "low risk aversion" scenario by 2094 (10.6 feet NAVD 88), then the bulkhead can be raised without further bayward encroachment.
- 5. The finished floor elevation of the proposed single-family residence is 13.2 feet (NAVD 88), which complies with the minimum 9.00-foot (NAVD 88) elevation standard. The Coastal Hazard Report concludes that the bay water elevation (currently 7.7 feet NAVD 88) will not exceed the proposed finished floor of the single-family residence at elevation 13.2 feet (NAVD 88) for the anticipated 75-year life of the structure.
- 6. Pursuant to NBMC Section 21.30.030(C)(3)(i)(iv), the property owner will be required to enter into an agreement with the City waiving any potential right to protection to address situations in the future in which the development is threatened with damage or destruction by coastal hazards (e.g., waves, erosion, and sea level rise). The property owner will also

be required to acknowledge any hazards present at the site and unconditionally waive any claim to damage or liability against the decision authority, consistent with NBMC Section 21.30.015(D)(3)(c). Both requirements are included as conditions of approval that will need to be satisfied prior to final building inspection, and prior to the issuance of building permits, respectively.

- 7. The property is located in an area known for the potential of seismic activity and liquefaction. All projects are required to comply with the California Building Code (CBC) and Building Division standards and policies. Geotechnical investigations specifically addressing liquefaction are required to be reviewed and approved prior to the issuance of building permits. Permit issuance is also contingent on the inclusion of design mitigation identified in the investigations. Construction plans are reviewed for compliance with approved investigations and CBC prior to building permit issuance.
- 8. The project design addresses water quality with a construction erosion control plan that outlines temporary Best Management Practices (BMPs) to be implemented during construction to minimize erosion and sedimentation, and to minimize pollution of runoff derived by construction chemicals and materials.
- 9. The project design includes a post-construction drainage system that includes drainage and percolation features designed to retain dry weather and minor rain event runoff onsite. Any water not retained on-site is directed to the City's storm drain system.
- 10. The property fronts the Newport Bay. Pursuant to NBMC <u>Section 21.35.030 (Construction Pollution Prevention Plan)</u>, a Construction Pollution Prevention Plan (CPPP) is required to implement temporary Best Management Practices (BMPs) during construction to minimize erosion and sedimentation and to minimize pollution of runoff and coastal waters derived from construction chemicals and materials. A CPPP has been prepared and included in the plan sets for review and approval prior to the issuance of construction permits. Construction plans and activities will be required to adhere to the approved CPPP.
- 11. Pursuant to NBMC Section 21.35.050 (Water Quality and Hydrology Plan), because of the site's proximity to the water and because the development contains more than 75 percent of impervious surface area, a Water Quality and Hydrology Plan (WQHP/WQMP) was prepared by Toal Engineering, Inc., dated February 7, 2019. The final WQHP/WQMP will be required to be reviewed and approved by the City's Engineer Geologist prior to building permit issuance. The WQHP/WQMP includes a polluted runoff and hydrologic site characterization, treatment control BMPs, use of a low-impact development approach and bioretention system to retain the design storm runoff volume on-site, and documentation of the expected effectiveness of the proposed BMPs. Construction plans will be required to comply with the approved WQHP/WQMP prior to the issuance of building permits.
- 12. Proposed landscaping complies with Implementation Plan Section 21.30.075. A condition of approval is included that requires drought-tolerant species. Prior to issuance of building permits, the final landscape plans will be reviewed to verify invasive species are not planted.

13. The project site is not located adjacent to a coastal view road, public access way, or coastal viewpoint as identified in the Coastal Land Use Plan. The nearest coastal viewpoint is located at the end of Harbor Island Drive and is not visible from the site. The proposed single-family residence complies with all applicable Local Coastal Program (LCP) development standards and maintains a building envelope consistent with the existing neighborhood pattern of development. The front setback along the harbor is 15 feet and only allows improvements with a maximum height of 42 inches. Additionally, the project does not contain any unique features that could degrade the visual quality of the coastal zone.

#### Finding:

B. Conforms with the public access and public recreation policies of Chapter 3 of the Coastal Act if the project is located between the nearest public road and the sea or shoreline of any body of water located within the coastal zone.

#### Facts in Support of Finding:

- 1. The project site is located on a privately gated island between the nearest public road and the sea or shoreline. Implementation Plan Section 21.30A.040 requires that the provision of public access bear a reasonable relationship between the requirement and the project's impact, and be proportional to the impact. In this case, the project replaces an existing single-family residence located on an R-1 lot with a new single-family residence. Therefore, the project does not involve a change in land use, density or intensity that will result in increased demand on public access and recreation opportunities. Furthermore, the project is designed and sited (appropriate height, setbacks, etc.) so as not to block or impede existing public access opportunities.
- Vertical access to the harbor is available at the Balboa Basin, approximately 2,000 feet east of the property. Vertical and lateral access to the beach and harbor is also available at street ends throughout Balboa Island, approximately 1,300 feet southeast of the property. The project does not include any features that would obstruct access along these routes.

#### SECTION 4. DECISION.

#### NOW, THEREFORE, BE IT RESOLVED:

- 1. The Zoning Administrator of the City of Newport Beach hereby finds this Project is categorically exempt from the California Environmental Quality Act ("CEQA") pursuant to Section 15303 under Class 3 (New Construction or Conversion of Small Structures) of the CEQA Guidelines, California Code of Regulations, Title 14, Division 6, Chapter 3, because it has no potential to have a significant effect on the environment.
- The Zoning Administrator of the City of Newport Beach hereby approves Coastal Development Permit No. CD2019-011, subject to the conditions set forth in Exhibit "A," which is attached hereto and incorporated by reference.

- 3. This coastal development permit is intended to cover portions of the project within the City's permit authority under the certified Local Coastal Program. The portions of the project within the Harbor Island Tidelands are within the California Coastal Commission's coastal permit jurisdiction boundary and therefore require their review.
- 4. This action shall become final and effective 14 days following the date this Resolution was adopted unless within such time an appeal or call for review is filed with the Community Development Director in accordance with the provisions of Title 21 Local Coastal Implementation Plan, of the Newport Beach Municipal Code. Final action taken by the City may be appealed to the Coastal Commission in compliance with Section 21.64.035 of the City's certified LCP and Title 14 California Code of Regulations, Sections 13111 through 13120, and Section 30603 of the Coastal Act.

PASSED, APPROVED, AND ADOPTED THIS 14 <sup>H</sup> DAY OF NOVEMBER, 2019	PASSED,	APPROVED,	<b>AND ADOP1</b>	ED THIS 14H	DAY OF NO	VEMBER, 201
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Jim Campbell, Zoning Administrator	

#### **EXHIBIT "A"**

#### **CONDITIONS OF APPROVAL**

- 1. The development shall be in substantial conformance with the approved site plan, floor plans and building elevations stamped and dated with the date of this approval (except as modified by applicable conditions of approval).
- 2. Prior to finalization of building permits for the new residence, the existing bulkhead or similar flood protection improvement shall be raised or replaced to provide a minimum elevation of 10.6 feet (NAVD 88). All improvements shall occur landward of the existing bulkhead. The plans shall also demonstrate that the wall can be augmented to a greater height if the future sea level rise is greater than the likely estimate of the "low risk aversion" scenario by 2094 (10.6 feet NAVD88).
- 3. Prior to the issuance of a Certificate of Occupancy, an agreement in a form approved by the City Attorney between the property owner and the City shall be executed and recorded waiving rights to the construction of future shoreline protection devices including the repair and maintenance, enhancement, reinforcement, or any other activity affecting the bulkhead, that results in any encroachment seaward of the authorized footprint of the bulkhead or other shoreline protective device. The agreement shall be binding against the property owners and successors and assigns.
- 4. Prior to the issuance of a building permit, the property owner shall submit a notarized signed letter acknowledging all hazards present at the site, assuming the risk of injury or damage from such hazards, unconditionally waiving any claims of damage against the City from such hazards, and to indemnify and hold harmless City, its City Council, its boards and commissions, officials, officers, employees, and agents from and against any and all claims, demands, obligations, damages, actions, causes of action, suits, losses, judgments, fines, penalties, liabilities, costs and expenses (including without limitation, attorney's fees, disbursements and court costs) of every kind and nature whatsoever which may arise from or in any manner relate (directly or indirectly) to City's approval of development. This letter shall be scanned into the plan set prior to building permit issuance.
- 5. No demolition or construction materials, equipment debris, or waste, shall be placed or stored in a location that would enter sensitive habitat, receiving waters, or a storm drain or result in impacts to environmentally sensitive habitat areas, streams, the beach, wetlands or their buffers. No demolition or construction materials shall be stored on public property.
- 6. This approval does not authorize any new or existing improvements (including landscaping) on State tidelands, public beaches, or the public right-of-way.
- 7. This Coastal Development Permit does not authorize any development bayward of the private property.
- 8. The applicant is responsible for compliance with the Migratory Bird Treaty Act. In compliance with the (MBTA), grading, brush removal, building demolition, tree trimming,

and similar construction activities shall occur between August 16 and January 31, outside of the peak nesting period. If such activities must occur inside the peak nesting season from February 1 to August 15, compliance with the following is required to prevent the taking of Native Birds pursuant to MBTA:

- A. The construction area shall be inspected for active nests. If birds are observed flying from a nest or sitting on a nest, it can be assumed that the nest is active. Construction activity within 300 feet of an active nest shall be delayed until the nest is no longer active. Continue to observe the nest until the chicks have left the nest and activity is no longer observed. When the nest is no longer active, construction activity can continue in the nest area.
- B. It is a violation of state and federal law to kill or harm a native bird. To ensure compliance, consider hiring a biologist to assist with the survey for nesting birds, and to determine when it is safe to commence construction activities. If an active nest is found, one or two short follow-up surveys will be necessary to check on the nest and determine when the nest is no longer active.
- 9. Best Management Practices (BMPs) and Good Housekeeping Practices (GHPs) shall be implemented prior to and throughout the duration of construction activity as designated in the Construction Erosion Control Plan.
- 10. The discharge of any hazardous materials into storm sewer systems or receiving waters shall be prohibited. Machinery and equipment shall be maintained and washed in confined areas specifically designed to control runoff. A designated fueling and vehicle maintenance area with appropriate berms and protection to prevent spillage shall be provided as far away from storm drain systems or receiving waters as possible.
- 11. Debris from demolition shall be removed from work areas each day and removed from the project site within 24 hours of the completion of the project. Stock piles and construction materials shall be covered, enclosed on all sites, not stored in contact with the soil, and located as far away as possible from drain inlets and any waterway.
- 12. Trash and debris shall be disposed in proper trash and recycling receptacles at the end of each construction day. Solid waste, including excess concrete, shall be disposed in adequate disposal facilities at a legal disposal site or recycled at a recycling facility.
- 13. Revisions to the approved plans may require an amendment to this Coastal Development Permit or the processing of a new coastal development permit.
- 14. The project is subject to all applicable City ordinances, policies, and standards, unless specifically waived or modified by the conditions of approval.
- 15. The applicant shall comply with all federal, state, and local laws. Material violation of any of those laws in connection with the use may be cause for revocation of this Coastal Development Permit.

- 16. This Coastal Development Permit may be modified or revoked by the Zoning Administrator if determined that the proposed uses or conditions under which it is being operated or maintained is detrimental to the public health, welfare or materially injurious to property or improvements in the vicinity or if the property is operated or maintained so as to constitute a public nuisance.
- 17. Prior to the issuance of building permits, the applicant shall submit a final construction erosion control plan. The plan shall be subject to the review and approval by the Building Division.
- 18. Prior to the issuance of building permits, the applicant shall submit a final drainage and grading plan. The plan shall be subject to the review and approval by the Building Division.
- 19. Prior to the issuance of building permits, a copy of the Resolution, including conditions of approval Exhibit "A" shall be incorporated into the Building Division and field sets of plans.
- 20. Prior to issuance of building permits, the applicant shall submit to the Planning Division an additional copy of the approved architectural plans for inclusion in the Coastal Development file. The plans shall be identical to those approved by all City departments for building permit issuance. The approved copy shall include architectural sheets only and shall be reduced in size to 11 inches by 17 inches. The plans shall accurately depict the elements approved by this Coastal Development Permit.
- 21. Prior to the issuance of building permits, the final WQHP/WQMP shall be reviewed and approved by the Building Division. Implementation shall be in compliance with the approved CPPP and WQHP/WQMP and any changes could require separate review and approval by the Building Division.
- 22. Prior to the issuance of building permits, the applicant shall submit a final landscape and irrigation plan. These plans shall incorporate drought tolerant plantings, non-invasive plant species and water efficient irrigation design. The plans shall be approved by the Planning Division.
- 23. All landscape materials and irrigation systems shall be maintained in accordance with the approved landscape plan. All landscaped areas shall be maintained in a healthy and growing condition and shall receive regular pruning, fertilizing, mowing, and trimming. All landscaped areas shall be kept free of weeds and debris. All irrigation systems shall be kept operable, including adjustments, replacements, repairs, and cleaning as part of regular maintenance.
- 24. Prior to the issuance of building permit, the applicant shall pay any unpaid administrative costs associated with the processing of this application to the Planning Division.
- 25. Should the property be sold or otherwise come under different ownership, any future owners or assignees shall be notified of the conditions of this approval by the current property owner or agent.

- 26. This Coastal Development Permit No. CD2019-011 shall expire unless exercised within 24 months from the date of approval as specified in Section 21.54.060 (Time Limits and Extensions) of the Newport Beach Municipal Code, unless an extension is otherwise granted.
- 27. Prior to the issuance of building permits, the applicant shall obtain a coastal development permit or other authorization of improvement for areas within the California Coastal Commission's permit jurisdiction, as determined by the California Coastal Commission.
- 28. To the fullest extent permitted by law, applicant shall indemnify, defend and hold harmless City, its City Council, its boards and commissions, officials, officers, employees, and agents from and against any and all claims, demands, obligations, damages, actions, causes of action, suits, losses, judgments, fines, penalties, liabilities, costs and expenses (including without limitation, attorney's fees, disbursements and court costs) of every kind and nature whatsoever which may arise from or in any manner relate (directly or indirectly) to City's approval of Pickup Residence including, but not limited to, Coastal Development Permit No. CD2019-011 (PA2019-051). This indemnification shall include, but not be limited to. damages awarded against the City, if any, costs of suit, attorneys' fees, and other expenses incurred in connection with such claim, action, causes of action, suit or proceeding whether incurred by applicant, City, and/or the parties initiating or bringing such proceeding. The applicant shall indemnify the City for all of City's costs, attorneys' fees, and damages, which City incurs in enforcing the indemnification provisions set forth in this condition. The applicant shall pay to the City upon demand any amount owed to the City pursuant to the indemnification requirements prescribed in this condition.

# **Attachment No. ZA 2**

Vicinity Map

# **VICINITY MAP**



Coastal Development Permit No. CD2019-011 PA2019-051

23 Harbor Island

# **Attachment No. ZA 3**

Project Plans



## The Pickup Residence 23 Harbor Island Newport Beach, CA

#### INDEX OF DRAWINGS

#### ARCHITECTURAL COVED ONEET

ARCHITECTURAL SITE BLAN (1/4" - 1' 0")

SLAB EDGE PLAN (1/4" = 1'-0"

MAIN LEVEL FLOOR PLAN (1/4" = 1'-0") SECOND LEVEL FLOOR PLAN (1/4" = 1'-0") ROOF PLAN (1/4" = 1'-0")

EXTERIOR ELEVATIONS (1/4" = 1'-0") EXTERIOR ELEVATIONS (1/4" = 1'-0")

MAIN LEVEL ELECTRICAL PLAN (1/4" = 1'-0") SECOND LEVEL ELECTRICAL PLAN (1/4" = 1'-0")

MAIN LEVEL REFLECTED CEILING PLAN (1/4" = 1'-0") SECOND LEVEL REFLECTED CEILING PLANS (1/4" = 1'-0")

OVERLAY PLANS (1/4" = 1'-0")

#### STRUCTURAL

CIVIL

LANDSCAPE

Zoning Requirements

Lot Area:

Proposed Floor Area

Required Open Space (4.485 Sq. Ft. x 15%)

Proposed Open Space: First Floor Entry Courtys Second Floor Entry Cou

Area Tabulations

First Floor (Livable):

Pool Equipmen

Proposed Building Area

7.793 Sq. Ft.

4.485 Sq. Ft.

8.970 Sq. Ft.

6.357 Sq. Ft.

673 Sq. Ft.

1.774 Sq. Ft.

20' x 28'-3"

1,924 Sq. Ft

5,462 Sq. Ft.

5,462 Sq. Ft. 895 Sq. Ft.

# **Forest**Studio

#### ritner group

EOS SONID STREET SLITTE 130

TELEPHONE: (949) 999-3255 FAX: (949) 999-3259



## **PICKUP** RESIDENCE

23 Harbor Island Newport Beach, CA 92663

TELEPHONE:

DRAWN BY: PRO IECT NI IMBER: 18001 PROJECT CAD FILE: 18001-PLN-COVER

COVER SHEET

PROJECT DIRECTORY

STRUCTURAL RIGHT ENGINEERIN

#### VICINITY MAP



T-24 HERITAGE ENERGY GROUP 470 WALD IRVINE, CA 92618 PHONE: (949) 789-722 CONTACT: RUDY SA

	ABBREVIATIONS						
3	ANCHOR BOLT	FAU	FORCED AIR UNIT	NG	NATURAL GRADE	T&B	TOP AND BOTTOM
0	AIR CONDITIONING	FDN	FOUNDATION	NIC	NOT IN CONTRACT	TC	TRASH COMPACTOR
T.	ALTERNATE	FF	FINISH FLOOR	NO	NUMBER	TEL	TELEPHONE
	ALUMINUM	FG	FUEL GAS / FINISH GRADE	NTS	NOT TO SCALE	T&G	TONGUE AND GROOVE
PROX	APPROXIMATELY	FIN	FINISH			TOC	TOP OF CURB
)	AREA DRAIN	FJ	FLOOR JOIST	OC	ON CENTER	TOM	TOP OF MASONRY
		FLR	FLOOR	OPP	OPPOSITE	TOP	TOP OF PAVING
DG	BUILDING	FLUOR	FLUORESCENT	OPT	OPTIONAL	TOW	TOP OF WALL
KG	BLOCKING	FOM	FACE OF MASONRY	OSA	OUTSIDE AIR	TV	TELEVISION
A	BEAM	FOS	FACE OF STUD			TYP	TYPICAL
M	BOTTOM	FT	FOOT/FEET	PB	PUSH-BUTTON	TB	TOWEL BAR
	CASTIRON	FTG FD	FOOTING FLOOR DRAIN	PLYWD PR	PLYWOOD PAIR	TPD TEMP GI	TOILET PAPER DISPENSI
		FD	FLOOR DRAIN			TEMP GL	TEMPERED GLASS
'_	CEILING JOIST CEILING	GA	GAUGE	PSF PSI	POUNDS/SQUARE FOOT POUNDS/SQUARE INCH	LIBC	LINIFORM BUILDING COD
.G .R	CLEUNG	GALV	GAUGE GALVANIZED	PTDF	PRESSURE TREATED	LINEIN	UNIFORM BUILDING COL
H.	COLLIMN	GD	GARRAGE DISPOSAL	PIDE	DOLIGIAS FIR	UNFIN	UNLESS OTHERWISE NO
INC.	CONCRETE	GLR	GILIE LAMINATED REAM	PVC	POLY VINYL CHLORIDE	OON	UNLESS OTHERWISE NO
INST	CONSTRUCTION	GLB	GAI VANIZED BEAM	PVC	POLT VINTE CHEURIDE	VERT	VERTICAL
TAC	CONTINUOUS	GI	GLASS / GLAZING	R	RADIUS	VERI	VENT THROUGH ROOF
JRT	CURTAIN	GYPBD	GYPSUM WALLBOARD	RAG	RETURN AIR GRILLE	V	VOLTS
	CUITAIN	HC HC	HOLLOW CORE	RD	ROOF DRAIN		FOLID
	DRYER	HDR	HEADER	RDWD	REDWOOD	w	WASHER
SL.	DOUBLE	HORIZ	HORIZONTAL	REFR	REFRIGERATOR	w	WITH
-	DRINKING FOLINTAIN	Home	HUMILUMIAL	REINE	REINFORCING	WC	WATER CLOSET
T	DETAIL	INSUL	INSULATION	REQ'D	REQUIRED	WD	WOOD
Δ	DIAMETER	INT	INTERIOR	R.I	ROOF JOIST	WDW	WINDOW
AG	DIAGONAL			RO	ROUGH OPENING	WH	WATER HEATER
м	DIMENSION	LB	LAG BOLT			WI	WROUGHT IRON
1	DOUBLE HUNG	LTWT	LIGHTWEIGHT	SC	SOLID CORE	W/D	WITHOUT
4	DOWN			SS	SELECT STRUCTURAL		
VG.	DRAWING	MAS	MASONRY	SH	SINGLE HUNG		
3	DOWNSPOUT	MAX	MAXIMUM	SHTG	SHEATHING		
2	DOOR	MB	MACHINE BOLT	SHOW	SHOWER		
SP	DISPOSAL	MC	MEDICINE CABINET	SIM	SIMILAR		
		MFR	MANUFACTURER	SL	SLIDING		
L.	EACH	MIN	MINIMUM	S&P	SHELF AND POLE		

#### **LEGEND**





#### 10. RECYCLE AND OR SALVAGE FOR REUSE A MINIMUM OF 65% OF THE NON-HAZARDOUS CONSTRUCTION AND DEMOLITION WASTE IN ACCORDANCE WITH SECTION 4.408.1 CalGreen CODE.

11 DEFERRED SURMITTAL TO BE REVIEWED BY PROJECT ARCHITECT OR ENGINEER OF RECORD AND CERTIFIED PRIOR TO SUBMIT FOR PLAN CHECK OR APPROVAL BY THE CITY.

SPECIAL INSTRUCTIONS: FIRE SPRINKLER SYSTEM - NFPA 13D OBTAIN FIRE SPRINKLER PERMIT PRIOR TO CALLING FOR ROOF SHEATHING INSPECTION

DEFERRED SUBMITTALS: FIRE SPRINKLER - NFPA 13D SYSTEM THROUGHOUT INCLUDING ATTIC HVAC FOLIPMENT AND DUCTWORK

ENCROACHMENT PERMIT NEW SINGLE FAMILY DETACHED

PROJECT DESCRIPTION: PROPOSED USE: NUMBER OF STORIES: CONSTRUCTION TYPE: OCCUPANCY:

V-B R-1 DWELLINGS, U- GARAGES REQUIRED, CRC SEC. R313.3 SYSTEM - NFPA 13D SYSTEM FIRE SPRINKLERS:

THROUGHOUT INCLUDING ATTIC PER R309.6, R313.1, R313.2 & R313.3

ZONING: R-1

2016 CALIFORNIA RESIDENTIAL CODE 2016 CALIFORNIA MECHANICAL CODE 2016 CALIFORNIA PLUMBING CODE 2016 CALIFORNIA ELECTRICAL CODE 2016 CALIFORNIA ENERGY CODE 2016 CALIFORNIA GREEN BUILDING STANDARDS CODE
2016 CALIFORNIA ENERGY EFFICIENCY
STANDARDS CODE
CITY OF NEWPORT BEACH REGULATIONS

| SOILS REPORT: | PREPARED BY: | PETRA | DATED | 00-00-2018 | REPORT No 00-0000 | DATED | 00-00-2018 |

#### INSPECTION PROGRAM:

- DEPUTY INSPECTORS ARE REQUIRED TO BE REGISTERED WITH THE CITY OF NEWPORT BEACH.
- SPECIAL AND / OR DEPUTY INSPECTIONS SHALL BE PROVIDED DURING CONSTRUCTION ON THE FOLLOWING TYPES OF WORK:

PORTION OF WORK REQUIRING INSPECTION DESCRIPTION, LOCATIONS, REMARKS, ETC. EXPANSION / EPOXY ANCHORS ALL STRUCTURAL WELDING SHEAR WALL NAILING STRUCTURAL MASONRY GROUTING, STEM AND FOOTING REINF. "HERS" VERIFICATION

#### PROJECT DATA

PROJECT ADDRESS 23 HARBOR ISLAND NEWPORT BEACH, CA. 92663 ASSESOR'S PARCEL NUMBER: 050-230-27 LOT 22 - TRACT 802

#### GENERAL NOTES:

- THE UTILITY CONSULTING ENGINEER IS TO ATTEND ON-SITE MEETINGS WITH THE UTILITY COMPANIES TO DETERMINE ALLOWABLE LOCATIONS. A
- REQUIRED HERS TESTING AND/OR VERIFICATION MUST BE DONE BY A CERTIFIED HOME ENERGY RATTER UNDER THE SUPERVISION OF A CEC-APPROVED HERS PROVIDER USING CEC APPROVED TESTING AND/OR VERIFICATION METHODS AND MUST BE REPORTED ON THE CF-4R INSTALLATION CERTIFICATE.
- 3. ISSUANCE OF A BUILDING PERMIT BY THE CITY OF NEWPORT ISSUANCE OF A BUILDING PERMIT BY THE CITY OF NEWPORT BEACH DOES NOT RELIEVE APPLICATIS OF THE LEGAL. REQUIREMENTS TO OBSERVE COVENANTS, CONDITIONS AND RESTRICTIONS WHICH MAY BE RECORDED AGAINST THE PROPERTY OR TO OBTAIN PLANS, YOU SHOULD CONTAC YOUR COMMUNITY ASSOCIATIONS PRIOR TO COMMENCEMENT OF ANY CONSTRUCTION AUTHORIZED BY THIS PERMIT.
- 4. PRIOR TO PERFORMING ANY WORK IN THE CITY RIGHT-OF-WAY
  AN ENCROACHMENT PERMIT MUST BE OBTAINED FROM THE PUBLIC WORKS DEPARTMENT.
- 5. A Cal-OSHA PERMIT IS REQUIRED FOR EXCAVATIONS DEEPER THAN 5'-0" AND FOR SHORING AND UNDERPINNING. CONTRACTOR TO PROVIDE A COPY OF OSHA PERMIT.
- 6. THE PROJECT LANDSCAPE AREA SHALL BE LESS THAN 500 sf POOLS, SPAS, WALLS, FENCES, PATIO COVERS AND OTHER FREESTANDING STRUCTURES REQUIRE SEPARATE REVIEWS AND PERMITS.
- FENCES, HEDGES, WALLS, RETAINING WALLS, GUARDRAILS AND HANDRAILS OR ANY COMBINATION THEREOF SHALL NOT EXCEED 42° FROM EXISTING GRADE PRIOR TO CONSTRUCTION WITHIN THE REQUIRED FRONT YARD SETBACK AREA.
- ALL PERMITS RELATED TO THE PROPOSED PROJECT SHALL BE ISSUED AT THE SAME TIME, OR SEPARATE PLANS AND PLAN REVIEW WILL BE REQUIRED FOR ITEMS NOT ISSUED WITH THIS REVIEW.
- a. ACCESSORY STRUCTURES, DETACHED PATIO COVERS AND
- ALDESSORY 3 THOUSE TERLUS
  MASONRY OR CONCRETE FENCES OVER 3.5 FT HIGH
  RETAINING WALLS OVER 4 FROM BOTTOM OF FOUNDATION TO
  TOP OF WALL

DEMOLITION OF EXISTING TWO-STORY RESIDENCE, GARAGE AND ASSOCIATED LANDSCAPING.

CONSTRUCT NEW TWO-STORY 5,462 s.f. SINGLE FAMILY RESIDENCE WITH AN ATTACHED 815 s.f. THREE CAR GARAGE. THE PROJECT INCLUDES HARDSCAPE AND SUBSURFACE DRAINAGE FACILITIES WITHIN THE CONFINES OF THE PRIVATE PROPERTY.

#### CAL GREEN - Residential Minimum Requirements



#### CITY OF NEWPORT BEACH

COMMUNITY DEVELOPMENT DEPARTMENT BUILDING DIVEJON 100 Civic Center Drive | P.O. Sen | 1705 | Neuport Seach, CA 92658-8915 1889, Septimber 10, 1909 (844-220)

DESIDERATION OF THE PROPERTY O

#### Energy Efficiency

- New one and two family dwellings and toenhouses with effected philodic garages shall install a lood roomed 1 and anote Gameter raceway to accommodifix a declared 206740 vot branch circuit. (4.106.4.1)
- (4.106.4.1)

  The momenty shall organize at the main service or hidgered and services this is lead clahest.
  The school of the service service is the service service of the serv

Annular spaces amound pose, electric coblex, conclub or other openings in scientations palase all electric width ethics produced against the passage of rodotes by cleaning such openings with searned morels, concern activation of the seaters affect, (4.0.5 t).
 Usbs or or of the city's approved Senctives having to require under swinge a minimum of 65% of the nonhamiltance construction and demanders waste. (4.2.5 t).

#### Water Efficiency and Conservation

New residential developments with an appreprie landstope area equal to or greater than 500 equare test shall comply with City's water efficient landscape or finance. (4.304.1, NBMC 14.17)

FIXTURE TYPE	MAXIMUM FLOW RATE
Single Showerheads	2.0 gpn di 80 sei
Multiple Showerheads	Contine flow rate of 2.0 gpm (\$60 psi
Residential Lavatory Faucets	1.2 gars (0.60 gas)*
Common and Public use Levelory Faucets	0.5 gan (\$60 pm
Köthen Faucets	1.6 gan (8.60 pm)
Matering Faucets	0.25 ostona ner cycle maximum
Water Closels	1.26 sations/bush
Wall Mounted Lininal	0.126 pelona/fush
At Other Types of Urinal	0.5 getone Rush

Holiste angle and that foot eater cours with an effective full rate of 1.28 years and 45th Arms 18 ht for dual flush street.

Literating Species and not have a five can tree from 1.5 years at 15 as:

#### **Environmental Quality**

- Montains content of building materials used in wall and floor framing is shecked before enclosure
- Modelar control and destinating a last 33 in Modelar control and the destination of the Modelar control and the destination of the Modelar control and the destination of the Agencies to the entirol page and shall be Modelar control and the Modela
- set and for Paring.
  Annex pares and contribute of the Perind-Leagues MM Links for RDC in Section
  MEXICATION and other tool requirements in Section MEXICATION (CITY of the Catherina Close of
  MEXICATION and other tool requirements in Section MEXICATION (CITY of the Catherina Close of
  Contribute Company requirements and the Contribute with the Reputing (4,504.5).

  a. Corplet and Sept Section And the Contribute with the Reputing (4,504.5).

  a. Corplet and Sept Section And the Contribution (CITY of the Reputing (4,504.5)).

  b. SEPANSE LEAGUES (ASSESSED AND ADMINISTRATION (CITY OF THE ADMINISTRATION CONTRIBUTED (ASSESSED AND ADMINISTRATION CONTRIBUTED AND ADMINISTRATION CONTRIBUT

- Consent Certifications Systems record Advantage\*\* One of the following (4,504.4).

  Information Stor from the security selection from the county with one of the following (4,504.4).

  Performance Product Desiration by Collebration for High Performance Scious (CIPTS) stign.

  Product certification and or LL CREETS/CAURAD God.

  Contract Companies of the Collebration (1,500.4).

  California Desiration of Public Health Sportscience (1,500.4).

  California Desiration of Public Health Sportscience (1,500.4).

Adhesives, sealants and caulis shall be compilert with usuable organic compound (VOC) limits set forth in Table 4.504.1 or Table 4.504.2. (4.504.2.1)

ACHESIVE VOC LIBIT () (Less Water and Lass Exempt Compliands in Gram	Contract Con
ARCHITECTURAL APPLICATIONS	AOC FINE
Indoor carpel adhesives	50
Carpet pad adhosives	50
Outdoor carpel adhesives	160
Wood fooring adhesive	100
Rubber foor adhesives	60
Subfloor adhesives	50
Ceramic the adhesives	45
VCT and asphalt ble achieves	50
Drywell and panel adhesives	50
Cove base adhesives	50
Multipurpose construction adhesives	70
Structural placing adhesives	100
Single oly roof membrane adhesives	250
Other adhesives not specifically total	50
SPECIALTY APPLICATIONS	
PvC weeding	610
CPVC welding	610 490
ABS weiding	326
Plastic cement welding	250
Adhesive primer for plastic	550
Contact adhesive	80
Special purpose contact adhesive	260
Sinuctural wood member achiesive	140
Top and from adhesive	250
SUBSTRATE SPECIFIC APPLICATIONS	
Motor to metal	30
Plastic foams	90 90
Porous material (except wood)	50
Wood	30
Feerpass	60

SEALANT VOC LIMI (Less Water and Less Exempt Compount	ts in Grama per Liter)
SEALANTS	VOC LIMIT
Architectural	250
Marine deck	250 760 300 250
Nonmembrane roof	500
Roadway	250
lingle-ply roof membrane	450
Other	420
SEALANT PRIMERS	
Architectural	20.0
Nonporous	260
Poroug	775
Modified bituminous	500
Marine deck	760
Other	760

Plaints, stains, and other costings shall be compliant with VOC and other toxic compound limits set forth in Table 4.504.3. (4.504.2.2)

VOC CONTENT LIMITS FOR ARCHITECTURAL (Grams of VOC per Liter of Coatin Less Water and Less Exempt Compo	ng. numde)
COATING CATEGORY	VOC LIMI
Flat coolings	50
Norflet coatings	100
Northe-high gloss costings	150
Specially Coatings	
Aluminum roof covings	400
Besement specially coalings	400
Siturtinous roof coatings	50
Bituminous roof primers	350
Rond breakers	360
Concrete ouring compounds	300
Concrete/mesorry sealers	100
Diveway sealers	50
Dry fog coeings	190
Faux friehing coatings	360
Fire resistive coatings	968
Floor coatings	100
Form-release compounds	250
Graphic arts coatings (sign paints)	900
High temperature coannes	420
Industrial maintenance coatings	250
Low solids coalings	120
Magnesite coment coatings	450
Mastic texture coatings	100
Material proposition continue	500
Multipolor coatings	250
Pretreatment wash primers	420
Primers, sealers, and undersoaters	100
Reactive penetrating sesters	360
Recycled coatings	250
Roof coatings	50
Rust preventative coatings	250
Shelaca	
Clear	750
Opaque	550
Specially primers, sealers and underspalers	100
Stains	250
Stone consolidants	450
Swimming poor coatings	340
Traffic marking coatings	100
Tub and tile refinish coatings	420
Weterproofing membranes	250
throad coatings	275
Wood preservatives	210
Zino-non primers	340

5. The operation shows no other cross selections as less than a better independ out of the common the common than the common term from these searches by the Continues for Security Section 1, 1988, about the common term from the common term of the common terms of the

Particibitions, medium density Storboard (MDF) and Nectocod physicial used in interior or extensi of the building shall comply with low formaldehyde emission standards as set form in Table 4.504.5 hallow (4.504.5).

PRODUCT	LIMIT
tardwood plywood veneer core	0.06
tantwood plywood composite core	0.05
articleboard	6.09
Actium density Merboard	6.11
hin medium density fiberboard	0.13

16. Berroom wahaset has shall be INSERTO'S 1914 ministed and the soleton is berroom whose the soleton is stronger or the soleton of the soleton or soleton of the soleton without separa. Note note that on each to soleton of the s

HVAC special inspectors must be qualified and able to demonstrate competence in the decipline they are impecting. (2022)

An operation and maintenance manual, CD, web-based reference or other approved media shall be provided by the builder to the building occupant or owner at the final inspection. It shall include operation and maintenance instruction of the explorent on deplanance, (4.4.10.1).

Documentation shall be provided to verify that fevals meterials used comply with VOC limits as set forth in Tables 4.064.1, 4.504.2, 3.4.004.3. (4.504.2.4)

22. Documentation shall be provided to verify that corporate wood products used comply with formaldehyde limits as set forth in Tables 4.304.5. (4.504.5.1)

CAL Green Documentation Compliance Certification forn (City form) is required to be submitted to the Building Inspector prior to final haliding Inspection. (Section 703.1)



#### ritner group

503 33ND STREET SHITE 130

TELEPHONE: (949) 999-3255 FAX: (949) 999-3259

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## PICKUP RESIDENCE

23 Harbor Island Newport Beach, CA 92663

TELEPHONE: FAX:

PROJECT MANAGER: RR PROJECT DESIGNER: BW DRAWN BY: PRO JECT NI IMBER: 18001 PROJECT CAD FILE: 18001-GBC NOTES

CAL GREEN RESIDENTIAL

MINIMUM REQUIREMENTS

GN-1



#### CITY OF NEWPORT BEACH

COMMUNITY DEVELOPMENT DEPARTMENT BUILDING DRYSSION Chris Center Drive 19.0. Box 1788 | Newport Beach, CA 92656-8915 New Designification agre (1649) 644-3207

#### RESIDENTIAL CONSTRUCTION MINIMUM REQUIREMENTS.

Applicatie Standards: 2016 California Residential Code (CRC); 2016 California Building Code (CRC); 2016 California Plumbing Code (CRC); 2016 California Electrical Standards (ERES); 2016 California Green Building Standards Code (California Green Building Standards Code (California Creen Building Standards Code (California Creen); & Chapter 15 of the Newport Basch Marricipal Code (NIMC)

Residential bulding undergoing permitted alterations, additions or improvements shall replace non-compliate planting fatures with water-consering stating fatures recting the requirements of 30% California Green Bulding Standards Code, Section 4332, and the stating of the code of faul improved replacement in sequence por a lauracies of a destination of the code of faul improved the stating of the stating

- Its Louise.

  Itsuance of a building permit by the City of Newport Beach does not relieve applicants of the legal requirements to observe coversants, conditions and restrictions, which may be recorded against the property or to obtain plans. You should contact your community associations prior to commencement of any correluction authorized by this permit.
- Prior to performing any work in the city right-of-way an encroachment permit must be obtained from the Public Works Department.
- ocasines from the Hubor vorous buparaneer.

  A alls surveys by a foreneed surveyor shall be required prior to foundation concrete pour.

  Garage ceiling height. The minimum unobstructed vertical clearance for perking spaces shall be seven hele except that the front four first may have a minimum vertical clearance of four feet, VBMC 22 49 000 44 or
- Utilize one of the city's approved franchise hauler to recycle and/or salvage a minimum of 65% of the nonhazardous construction and demolition waste. (Cal Green 4.408.1). 4.408.5)
- Starways shall not be less tran 36 inches clear width. (CRC 311.7.1) The minimum head clearance shall be 6'-8' measured vertically from the stoped line adjoiring tread nosing. (CRC 311.7.2)
- Advisory Note: Homeowners Association (HOA) approval may be required for this improvement.

- Total permits are required for detached shrutures including but not limited to: Accessory shrutures, detached paic covers, and trellises. Macrony or concrete limites over 5.5 ft. Right. Retaining wells over 4 ft. high from the bottom of the foundation to the top of the well.

#### CONSTRUCTION

	CBC TABLE 3386.1 PROTECTION OF PEDESTRIANS	
HEIGHT OF CONSTRUCTION	INSTANCE FROM CONSTRUCTION TO LOT LINE	THRE OF PROTECTION REQUIRED
it had or beat	Less than 6 had	Communication radings
	5 had at more	Now
More than it had	Less than 5 feet	Sparier and covered welves
	If fast or more, But not more than one-fourth the height of constructor	Barrier and covered wellvan
	S last or more, but believen one-burst and one-burst the height of complication.	tene

- All exterior lath and plaster shall have two layers of Grade D paper over wood base sheathing, ICRC 67703.7.3, CBC 2510.6)
- Wall covering of showers or tubs with showers shall be of cement plaster, tile, or approved equal, to a height of not less than 72 mohes above drain inlet. Backing for tile shall be cement board or cement glaster, (CRC RD72, CBC 1910-2.)
- Safety glazing shall be provided at the following hazardous locations: (CRC R308.4, CBC 2408.4)
- [4] Swinging, bi-fluid, and sliding doors. When boarded within 60 notices above the foor of west surfaces such as fulfill, which will be sufficiently adjusted to doors.
  [5] Within a 54 noth arc of either vertical edge of doors and within 60 inches of walking sufficient.

  - Where the glazing is on a wall perpendicular to the plane of the door in a closed position and within 24 inches of the hinge side of an in-ewinging slave.
- door.

  The gramp area is more than it sq. it, marea, with those object explaints in the source of th
- Olating adjacent to the landing at the bottom of a stairway where the glazing is less than 35 inches above the landing and within 60 inches horizontally of the

- bottom tread.

  G. Clazing in journels and railings.

  14. Aid doors from the focuse into the pool area shall be equipped with an approved slarm or an approved slarmes denoting prevention safety features. (CRC 3109.4.4.2)

  15. Simole alternes shall be installed in the following locations (CRC R314.3, CRC 907.2.11.2, 907.2.11.3, 807.2.11.4)
- Outside each separate sleeping area in the immediate vicinity of the bedrooms. On each additional story, including besements and habitable affice.

- Not less than 3 feet horizontally from the door or opening of a bethroom that contains a betholo or shower.

  A minimum of 20 feet horizontally from any permanently installed cooking appliance.
- Sproke alarms shall be hardwired with battery back-up and interconnected unless exempted in accordance with CRC R314.4 & R014.5 or CRC 907.2.11.5 & 907.2.11.6
- monoxide alarms shall be installed in the following ocasions (CRC R315.3):
- Outside of each sleeping area in the immediate vicinity of the bedroom(s). On every level of the dwelling unit including beaments. Where a fuel-burning appliance is located within a bedroom or its attached betroom, a carbon recrosola stems shall be installed within the bedroom. Carbon monoxide alarms shall be hardwired with battery back-up and interconnected unless exempted in accordance with CRC RD15.
- All fenestrations on windows and doors shall have U-factors (0.32 max) and Solar Heat Gain Coefficient (SHGC+0.25 max) values in accordance with T-24 energy-calculations. All fenestrations must have temporary and permanent labels.

#### TEMPORARY GENERATOR

- Amount assemblinates the provided by electricity must use power provided by Southern California (Silason brough a temporary pole or available outlet. In the riser case where selectricity is not availary available and a position the improving generator in recessary, then the following restrictions must be achieved to:

  a. Must be positized and may be easily relocated.
- Temporary generators are to be located a minimum distance from any property line according to the following table:

Time in Use Hours	Required Setback from Property Line	Required Setback from Adjacent Structures
0 - 1 day	10 feet	5 feet
> 1 day	20 feet	5 feet

- If the smirror distance cannot be solviewer, then the generator shall be located the most entering distance protected in which believes. One methods to which roles to entering distance protected to which roles. We have the protection of the stance of the consecutive calendar days of use, power shall be provided through the use of a temporary power government. One of the consecutive calendar days of use, power shall be provided through the use of a temporary power government.

  Usago is included to weekdays between the hours from Exc OAM and 3.30 FM Montally protectly findings. Not use on the weekening to follow the following.

#### FIREPLACE:

- Factory-fulli fregiaces, chimneys and all of their components shall be listed and installed in accordance with their listing and manufacturer's installation instructions, CIDR R1004.1) Factory but wood burning fregiaces shall be qualified at the U.S. EPA's Voluntary Fregiace Program Phase 2 emissions level.
- Fineptice Program Phase 2 emissions level.

  Decorative shroulds shall not be installed at the termination, of factory-built channeys except where such shrouds are lated and labeled for use with the appoint. Statory-built, channeys yestern and are installed in accordance with manufacturer's installed in in statistical or installed in accordance with manufacturer's installed in in statistical control (CRC R1005.2 & CMC 802.5.2.4)
- Horizontal openings are not allowed, for exhaust verts, in walls closer than 3 feet to a property line. (Tables R302.1(1)8(2)). Horizontal vent caps shall be 2 feet clear from property lines.
- Exhaust openings shall not be directed onto walkways. (R303.5.2)
- Solid fuel burning freplaces:
- Provide a permanently anchored gaseous fuel burning pan to the frebox of a solid fuel burning fireplace.

  Solid fuel burning fireplace must comply with the California Energy Standards managinary presentation.
- mandatory measures. Chipmay shall extend at least 2 ft. higher than any portion of the building within 10 ft, but shall not be less than 3 ft. above the highest point where the channey passes thought the roof. (CRC R1003 9) Liquid fueled freplaces are not allowed for interior use.
- 21. Direct vent gas appliance freplace:
  - Direct vert sealed-combustion gas appliance freplace must comply with the Cal Green code requirements and must comply with ANSI 221.50. (Cal Green 4.503.1)

- Rooms containing bethabs, showers, spas and similar flutures shall be provided with an exhaust fan with humidity control sensor having a minimum capacity of 50 CFM ducted to terminate outside the tuskling. (CRC R303.3, Cal Green 4.506.1, CBC 1203.6.2.1, CMC 402.3)
- Where water closet compertment is independent of the ballyzon or shower area, a far-will be required in each area. Betherons shall have an exhaust faw with humidity control sensor, min. 30 PM (apachy, (CRSB 3.) Where whole house fars are used in ballyzon areas, the fain must min continuously and shall not be det to a humidity control sensor, (Cid Green 4.506.1)
- The clothes dryer vent shall not exceed 14 ft, in overall length with maximum two 90 degree elbows. (CMC 504.4.2.1)
- Environmental air ducts shall terminate min. 3 feet from property line or openings into building, and 10 feet from a forced air risel. (CMC 902.2.1) Mechanical equipment shall be installed per the manufacture's installation instructions. (CMC 303.1)
- 28. Domestic range vents to be smooth metallic interior surface. (CMC 504.3)

Supply and return air ducts to be insulated at a minimum of R-6. (Cal Energy Code Table 150:1-A.)

- Separate water meters are required for all new duplexes. Separate fire risers are required at each water meter.
- Plumbing Fixtures: New Construction & Addition/Alterations that increases condition space area, volume, or size (Cel Green 4.303.1);
  i. Comply with CAL Green Mandatory Requirements

  - Addition & Alteration: Ealsting fatures shall be replaced to meet the following requirements:
- requirements

  1. Shower Heach: 2.0 gpm @ 80 psi

  8. Levstory Faucets: 1.2 gpm @ 90 psi

  8. Notwork Faucets: 1.5 gpm @ 90 psi

  10. Water Choset: 0.2 gbm g 90 psi

  10. Water Choset: 0.2 gbm g 90 psi

  10. Water Choset: 0.2 gbm g 91 handwe in front, and 15 inches from 6a centre to any side and or obstruction. (2014 620.5)
- The water heater burner to be at least 18 inches above the garage floor, if located in a garage. (CPC 507.13)
- Install a 3 high discrete: by 3 %, self-sized pipe emissions  $\Re$  connects slieb for protection of water heaters located in garage. (CPC 507, 13, 1)
- Water heaters to be strapped at too and bottom with 1 %" x 16 gauge strap with 3/6" dameter. X 3" lag bot each end, (CPC 597.2)
- ABS and PVC drain waste and vent piping material is limited to 2 stories maximum. (CPC 701.2(2) (a), and 903.1.1) ABS and PVC roof and deck drain material is limited to 2 stories maximum, (CPC 1101.4)
- Roof and deck drain systems inside the building are required to be installed with directional DWV drainage fittings. (CPC 1101.4 and & 706.0)
- Chancols are required within 2 feet of the connection between the interior roof and deck drain priori systems, and the extension naive storm asks experience. (CPC 1101.13) All hope bother are to have viewour theretars. (CPC 003.5.17) The macrourus amount of water closests on a 3 inch horizontal drainage system line is 3. (CPC 7 tale 7.03).
- The maximum amount of water closets on a 3 inch vertical drainage system line is 4. (CPC Table 703.2)
- Provide gas line with a min capacity of 200,000 bts for water heater. (Cal Energy Code 150,000)
- Provide a condensate drain no more than 2 inches above the base of the water heater space. (Call Energy Code 150.0 (n))
- Provide a straight vent pipe from the water heater space to the outside termination from the water heater space. (Call Energy Code 150.0 (n))
- 46. Insulate all hot water pipes. (Cal Energy Code 150.8 (j) (2), and CPC 609.11).

#### Isolation valves are required for tankiess water heaters on the hot and cold supply lines with hose bibbs on each valve, to flush the heat exchanger (Cal Energy Code 110.3 (7))

- Electrical service to be underground for new construction, replacement building, or addition to an existing building exceeds fifty (50) percent of the gross floor area of the existing building. (NBMC 15.32.015)
- Edison Company approval is required for meter location pror to installation
- Service equipment and subpanels to have a min 30" vide by 36" deep clear work space (CEC 110.20)
- All lighting is required to be high efficacy. (California energy code section 150. (k) and Table 150.0-A.)
- Provide a listed 1 inch raceway to accommodate a dedicated 206/240-volt circuit for future electrical vehicle (EV) charger. (Call Green 4:106.4)
- All receptacle outlets are required to be listed tamper resistant (CEC 406.12 and 250.52) Combination type AFCI circuit breakers are required for all 120 volt single phase 15/20 amp branch circuits. Except for bathrooms, garages, and outdoors. (CEC 210.12)
- At a minimum, one dedicated 20 amp circuit is required for a bethroom. (CEC 210.11(C)CR)
- OPCI prefection is required for all receptacle outlets located outdoors, garages, accessory buildings, bethrooms, crawl spaces, kitchens, laundy areas, kitchen dishwasher branch crout, garbage disposs, all areas within 5 feet of a sink, and all neceptacles within 6 feet of a bathast or shower stall. (CEC 2018)
- Receptacle outlets are not allowed within or over a bathfub or shower stall. (CEC 406.9 Subpanels are not allowed to be located in bathrooms or clothes closets. (CEC 240.24 (D) and (E).
- Circuits sharing a grounded conductor (neutral) with two ungrounded (hot) conductor must use a two pole circuit breaker or an identified handle tie. (CEC 210.4(B)) Group non cable circuits in panel (CEC 210.4(D))
- The receptable outlets that serve kitchen counter typs, diving room, breakfast area, and parity, must have a min of 2 dedicated 20 amp crouts. (CEC 210.52 (B)(1) Kitchen counter tops 17 inches or wider must have a receptable outlet. (CEC 210.52(C))
- Kitchen counter tops must have receptacle outlets so no point along the counter walls is more than 24 inches from a receptacle. (CEC 210.52 (C))
- Island and peninsular counter tops must have at least one receptacle. (CEC 210.52(C); 11,(2),and (3))
- The spacing for general receptacle outlets must be located so that no point on any wall, fixed glass, or cablents is over 6 feet from a receptacle outlet. (CEC 210.50(A))
  Hallways 10 feet or more must have at least one receptacle outlet. (CEC 210.50(A))

- Gerages shall have at least one receptacle for each car spece on the interior. The branch circuit supplying the receptacles shall not serve outlets outside of the garage. (CEC 210.52 (G)
- Laundry rooms must have at least one dedicated 20 amp receptacle circuit. (CEC 210.11(C)(2)).
- 69. Provide 120V receptacle within 3 feet of water heater. (Cal Energy Code 150.0 (n) 1 A.)

#### FOUNDATION:

- the same or 2 increas access pavid armain. (Linco Priod 1.2.), CoC 2512.1.2)
  Fasteners and connectors [nais, anchor bobs, etc.] in contact with preservative-freehed wood shall be of hot-disped sinc-coated galvanized steet, stantess steet, silcon bronze or copper. (CRC R317.5, CBC 2304.10.5.1)
- Anchor totis shall include steel plate washers, a minimum of 0.229" x 3" x 3" in size, between all plate and nut. (CRC R002.11.1, CBC 2306.3.2, Acceptable attenuate SDPWS 4.3.6.4.3).



#### ritner group

503 33ND STREET SHITE 130

TELEPHONE: (949) 999-3255 FAX: (949) 999-3259

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## PICKUP RESIDENCE


23 Harbor Island Newport Beach, CA 92663

TELEPHONE FAX:

PROJECT MANAGER: RR PROJECT DESIGNER: BW DRAWN BY: PRO IECT NI IMBER: 18001 PROJECT CAD FILE: 18001-GN2

RESIDENTIAL CONSTRUCTION MINIMUM REQUIREMENTS

GN-2

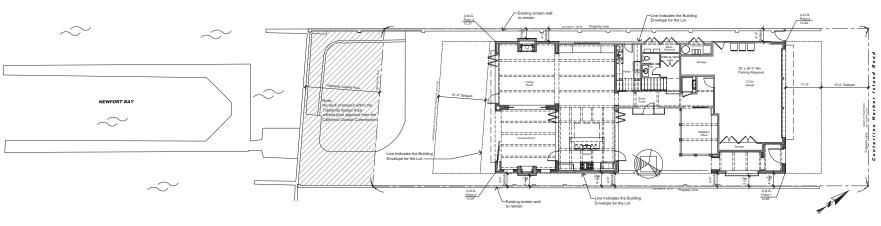

Lot 24

SCALE: 1/8" = 1'-0"

#### General Notes:

- Refer to Site Drainage Plan sheet for existing grade elevations and finish grade elevations.
- Surveyor or Engineer shall permanently monument property corners or offsets before starting grading.
- 3. Fences, Gates, Walls, Planter boxes, Patio covers, and other freestanding structures cannot exceed 6' measured from Natural Grade within required side yard setback.

Architectural Site Plan

- Finish grade within 10 feet of the new structure/ addition shall be sloped a minimum of 2 % away from the building for drainage purpose.
- Additions, remodels or renovations of a single family home with an existing pool require the suction outlet of the existing pool, spa, or toddler pool to be upgraded so as to be equipped with an approved anti-entrapment cover meeting the current standards of ASTM or ASME per section 115920 HSC.
- The discharge of pollutants to any storm drainage system is prohibited. No solid waste, petroleum byproducts, soil particulate, construction waste materials, or wastewater generated on construction shes or by construction activities shall be placed, conveyed or discharged into the street, gutter or storm drain system.
- In Accordance with Planning Area 6 (PA6) of the Headlands Development and Conservation Plan (HDCP), This house is a Single-Family Dwelling.
- An approved encroachment permit is required for all work activities within the public right-of-way, public easement and on city facilities.
- All work related to wastewater in the public right-of-way shall be performed by a C-42 licensed Sanitation Sewer Contractor or an A Licensed General Engineering Contractor.
- 10. A Public Works Department Encroachment Permit A Public Works Department Encoachment Permit inspection is required before the building Department Permit Final can be issued. At the time of Public Works Department inspection, if any of the assisting public improvements surrounding the site is damaged, new concrete sidewalk, cut and gutter, and alleysitreet pavement will be required. Additionally, if existing utilities infrastructure and edemed substandard, a new 1-inch water service, water meter box, sewer lateral and/or cleanout with box and fild will be required. 100% of the cost shall be borne by the property owner (Municipal Codes 14.24.020 and 14.08.030). Said determination and the extent of the repair work shall be made at the discretion of the Public Works Inspector.

#### Front: Sides: Front: (no projection of livin Buildable Lot Area: Allowable (4,485 x 2 Floor Area Limit: Proposed Floor Are Required Open Spa (4,485 Sq. Ft. x 159 Proposed Open Sp First Floor Entry Co Second Floor Entry Total Proposed Open Space 1,774 Sq. Ft. Maximum Building Height:

20' x 28'-3"

Parking Requirements: (3) Cars Minimum Clear Dimension

Zoning Requirements		Area Tabulations	
Lot Area:	7,793 Sq. Ft.	First Floor (Livable):	1,924 Sq. Ft
Sethacks:		Covered Entry Gallery:	170 Sq. Ft
Front:	15'	Covered Porch:	383 Sq. Ft
Sides:	4'	Second Floor (Livable):	2,985 Sq. Ft
Front:	15	Total (Livable):	5.462 Sq. Ft
(no projection of living space at secon	nd floor)		-,
		Garage:	815 Sq. Ft
Buildable Lot Area:	4.485 Sq. Ft.	Mechanical:	37 Sq. Ft
Allowable (4,485 x 2)	1,100.04.1	Pool Equipment:	43 Sq. Ft
Floor Area Limit:	8,970 Sq. Ft.	Total:	895 Sq. Ft
Proposed Floor Area:	6,357 Sq. Ft.	Proposed Building Area:	
		Total (Livable):	5,462 Sq. Ft
Required Open Space:		Garage / Mechanical:	895 Sq. Ft
(4,485 Sq. Ft. x 15%)	673 Sq. Ft.		
Proposed Open Space:		Total Proposed Building Area:	6,357 Sq. Ft
First Floor Entry Courtyard:	913 Sq. Ft.		
Second Floor Entry Courtyard:	861 Sq. Ft.	Allowable Building Area:	8,970 Sq. Ft

Tabulations		Grade Establishment
oor (Livable):	1,924 Sq. Ft.	Area for Determining slope Caculation
d Entry Gallery: d Porch: Floor (Livable):	170 Sq. Ft. 383 Sq. Ft. 2,985 Sq. Ft.	A.N.G. Point # 1 12.85' A.N.G. Point # 2 12.59' A.N.G. Point # 3 12.27'
ivable):	5,462 Sq. Ft.	A.N.G. Point # 4 12.82' Total 50.53'
	815 Sq. Ft.	Divided by 4
iical: juipment:	37 Sq. Ft. 43 Sq. Ft.	A.N.G. (Average Natural Grade) 12.63
ed Building Area:	895 Sq. Ft.	PROJECT ADDRESS 23 HARBOR ISLAND NEWPORT BEACH, CA. 92563 ASSESOR'S PARCEL NUMBER: 050-230-27
ivable):	5,462 Sq. Ft.	LOT 22. TRACT 802
/ Mechanical:	895 Sq. Ft.	



#### rither GROUP

503 32ND STREET, SUITE 130

TELEPHONE: (949) 999-3255 FAX: (949) 999-3259



## PICKUP RESIDENCE

23 Harbor Island Newport Beach, CA 92663

TELEPHONE: FAX:

PROJECT MANAGER: RR PROJECT DESIGNER: BW DRAWN BY: PROJECT NUMBER: 18001

PROJECT CAD FILE: 18001-PLN-SITE

ARCHITECTURAL SITE PLAN

SP-1

																							I
	WINDOW SCHEDULE													WINDOW NOTES									
			WINDOW						WIN			DUTES	/ARE	È	ERATING	fside pe side)	GLASS	NS NOORSON.	GLAZING		FENESTRATION		ton Frame Windows  1. All Glazing to be true divided lites. 2. All Glazing to be Laminated Glass Single Pane Tempered
SYM	ROOM NAME	SI		TYPE	FRAME MATERIAL	FINISH	DESCRIPTION	н	J	м	s	DIVIDE	HARDW.	QUANTITY	B 8	인물 Right	LOW -E	SCREEN SCREEN	GLAZING	REMARKS	N-VALU SHGC	MANUFACTURE	<ol> <li>The General Contractor, Framer and Door and Window Installer are to verify all Door and Window Openings with the Shop Drawings and field conditions. Dimensions provided on this Schadule are for the purpose of the preparation of the Door and Window Shop Drawings. All rody opening dimensions are to be coordinated with the Door</li> </ol>
Main Le	vel Windows						•																and Window Shop Drawings. (Failure to do so is the Responsibility of the General Contractor and Sub Contractor.)
W101	Natalie's Office	4'-0"	7'-0"	Α	Wood	Factory Stain Wired Brushed Finish	Fixed w/ Hopper Above	-/D2.1	-/D2.1	-/D2.1	-/D2.1	-	-	2	-	-		-	Dual Pane	Tempered		Millworks Etc., Inc.	Iron Frame Windows By: Steelworks Etc., Inc. 2596 Calche Circle Newbury Park, CA 91320
(W102)	Natalie's Office	3'-11"	7'-0"	А	Wood	Factory Stain Wired Brushed Finish	Fixed w/ Hopper Above	-/D2.1	-/D2.1	-/D2.1	-/D2.1	-	-	3	-	- 1		-	Dual Pane	Tempered		Millworks Etc., Inc.	Newbury Park, CA 91320 (805) 499-3400
(W103)	Kitchen	9'-0"	3'-0"	В	Steel Frame	Factory Finish	Awning (3) Operable lower Pane	-/D2.1	-/D2.1	-/D2.1	-/D2.1	10W2H	-	1	-	-			Dual Pane	-		Steelworks Etc., Inc.	Wood Windows
(W104)	Living	8'-0"	5'-0"	С	Wood	Factory Stain Wired Brushed Finish	(3) Unit Casement	-/D2.1	-/D2.1	-/D2.1	-/D2.1	6W2H	-	1					Dual Pane			Millworks Etc., Inc.	All Glazing to be true divided lites.     All Glazing to be Dual Pane
Second	Level Windows																						<ol> <li>The General Contractor, Framer and Door and Window Installer are to varify all Door and Window Openings with the Shop Drawings and field conditions. Dimensions provided on this Schedule are for the purpose of the preparation of the Door and Window Shop Drawings.</li> </ol>
W201	Bedroom 3 Retreat	5'-4"	4'-0"	D	Wood	Factory Stain Wired Brushed Finish	Pair / Mulled Double Hung	-/D2.1	-/D2.1	-/D2.1	-/D2.1	4W2H	-	1		-			Dual Pane	-		Millworks Etc., Inc.	All rogh opening dimensions are to be coordinated with the Door and Window Shop Drawings. (Failure to do so is the Responsibility of the General Contractor and Stut Contractor.)
(W202)	Bedroom 3 Retreat	4'-0	4'-0"	Е	Wood	Factory Stain Wired Brushed Finish	Double Hung	-/D2.1	-/D2.1	-/D2.1	-/D2.1	3W2H	-	4					Dual Pane	-		Millworks Etc., Inc.	Wood Windows By: Milworks Etc., Inc Doors and Windows
(W203)	Bedroom 4 Retreat	4'-0"	4'-0"	Е	Wood	Factory Stain Wired Brushed Finish	Double Hung	-/D2.1	-/D2.1	-/D2.1	-/D2.1	3W2H	-	2					Dual Pane	-		Millworks Etc., Inc.	2586 Calcite Circle Newbury Park, CA 91320 (805) 499-3400
(W204)	Bedroom 4 Retreat	5'-4"	4'-0"	D	Wood	Factory Stain Wired Brushed Finish	Pair / Mulled Double Hung	-/D2.1	-/D2.1	-/D2.1	-/D2.1	4W2H	-	1		,			Dual Pane	-		Millworks Etc., Inc.	General notes
(W205)	Bedroom 4	4'-0"	4'-6"	F	Wood	Factory Stain Wired Brushed Finish	Pair Casement	-/D2.1	-/D2.1	-/D2.1	-/D2.1	4W3H	-	1					Dual Pane	-		Millworks Etc., Inc.	Fenestrations must have temporary and permanent labels     Ducts must be sealed and field verified by a HERS certified special inspector.
(W206)	Bedroom 4	3'-6"	4'-0"	G	Wood	Factory Stain Wired Brushed Finish	Double Hung	-/D2.1	-/D2.1	-/D2.1	-/D2.1	3W2H	-	1	-	-			Dual Pane	-		Millworks Etc., Inc.	The load resistance of glass under uniform load shall be determined in accordance with ASTM E 1300.
(W207)	Bath 4	2'-0"	2'-0"	Н	Wood	Factory Stain Wired Brushed Finish	Casement	-/D2.1	-/D2.1	-/D2.1	-/D2.1	2W2H	-	1		-			Dual Pane	-		Millworks Etc., Inc.	Gliazing notes  1. Each pane of safety glazing installed in hazardous locations
(W208)	Upper Family	4'-0"	4'-0"	E	Wood	Factory Stain Wired Brushed Finish	Double Hung	-/D2.1	-/D2.1	-/D2.1	-/D2.1	3W2H	-	2	-	-			Dual Pane			Millworks Etc., Inc.	shall be identified (acid etched, sand blasted, ceramic fired, etc) by a manufacturer's designation, the manufacturer or installer and the safety olizaine standard which it compless. Multi-oane assemblies
(W209)	Upper Family	3'-11"	4'-0"	Е	Wood	Factory Stain Wired Brushed Finish	Double Hung	-/D2.1	-/D2.1	-/D2.1	-/D2.1	3W2H	-	3	-	-	•	•	Dual Pane	-		Millworks Etc., Inc.	shall be identified liper CRC R308.1. [CRC R308.1] Glazing in swinging, sliding, and bifold doors 9 square feet or less
(W210)	Hall	3'-0"	4'-0"	J	Wood	Factory Stain Wired Brushed Finish	Casement	-/D2.1	-/D2.1	-/D2.1	-/D2.1	2W2H	-	2				•	Dual Pane	-		Millworks Etc., Inc.	shall be a minimum category classification of I ( CPSC 16 CFR 1201) and II (CPSC 16 CFR 1201) when more than 9 square feet or sliding.  2. [Table R308.3.1 (1), R308.3.1]
(W211)	Hall	6'-0"	4'-0"	К	Wood	Factory Stain Wired Brushed Finish	Fixed	-/D2.1	-/D2.1	-/D2.1	-/D2.1	6W2H	-	1	-		•	-	Dual Pane	Tempered		Millworks Etc., Inc.	Glazing over 9 square feet in area with bottom edge less than 18" above the floor and exposed by edge greater than 36" above the floor shall be safety glazed. [CRC R306.4.3]
W212	Master Gallery	3'-2"	4'-0"	L	Wood	Factory Stain Wired Brushed Finish	Casement	-/D2.1	-/D2.1	-/D2.1	-/D2.1	2W2H	-	2			•	•	Dual Pane	-		Millworks Etc., Inc.	<ol> <li>Gliazing in doors and enclosures for hot tubs, whirtpools, saumas, steam corns, bathrooms showers less than 5' above the standing surface shall have a minimum category classification of II (CPSC 16</li> </ol>
(W213)	Master Gallery	7'-6"	4'-0"	М	Wood	Factory Stain Wired Brushed Finish	Fixed	-/D2.1	-/D2.1	-/D2.1	-/D2.1	6W2H	-	1		-	•	-	Dual Pane	Tempered		Millworks Etc., Inc.	4. CFR 1201). [ CRC Table R308.3.1 (1) & 308.4.5]  Egress Notes
(W214)	Master Suite	3'-6"	4'-0"	Е	Wood	Factory Stain Wired Brushed Finish	Double Hung	-/D2.1	-/D2.1	-/D2.1	-/D2.1	3W2H	-	2	-	-	•	•	Dual Pane			Millworks Etc., Inc.	Every sleeping room shall have at least one operable emergency escape and rescue opening (Window or Door). Emergency escape and rescue
(W215)	Master Suite	5'-0"	4'-0"	Е	Wood	Factory Stain Wired Brushed Finish	Double Hung	-/D2.1	-/D2.1	-/D2.1	-/D2.1	3W2H	-	3	-	,		•	Dual Pane	-		Millworks Etc., Inc.	operainig shall open directly in a public way, or to a yard or court that 1. opers to a public way.  All Emergency excape and rescue openings shall have;
(W216)	Master Bath	5'-0"	4'-0"	Е	Wood	Factory Stain Wired Brushed Finish	Double Hung	-/D2.1	-/D2.1	-/D2.1	-/D2.1	3W2H	-	3	-	,	•	•	Dual Pane	-		Millworks Etc., Inc.	The bottom of the opening shall not be more than 44 inches above the floor.  Minimum set clear opening height of 24" and width of 20"  Minimum set clear opening of 5.7 square feet (5.0 at grade level)
(W217)	Master Shower	2'-0"	2'-0"	н	Wood	Factory Stain Wired Brushed Finish	Casement	-/D2.1	-/D2.1	-/D2.1	-/D2.1	2W2H	-	1	-	-	•	•	Dual Pane	Tempered		Millworks Etc., Inc.	Note: in order to meet the minimum clear opening of 5.7 square feet, either the width or height or both must exceed the minimum dimension (see
(W218)	Master WC	2'-6"	4'-0"	N	Wood	Factory Stain Wired Brushed Finish	Casement	-/D2.1	-/D2.1	-/D2.1	-/D2.1	2W2H	-	1		,			Dual Pane	-		Millworks Etc., Inc.	figure Below). The net clear opening dimensions required shall be obtained by the normal operation of the emergency escape and rescue opening from the inside.
(W219)	Master Walk-In	2'-6"	4'-0"	N	Wood	Factory Stain Wired Brushed Finish	Casement	-/D2.1	-/D2.1	-/D2.1	-/D2.1	2W2H	-	1					Dual Pane	-		Millworks Etc., Inc.	
(W220)	Laundry	2'-6"	4'-0"	N	Wood	Factory Stain Wired Brushed Finish	Casement	-/D2.1	-/D2.1	-/D2.1	-/D2.1	2W2H	-	1		-			Dual Pane	-		Millworks Etc., Inc.	Mr. Clasr
(W221)	Bath 2	2'-6"	4'-0"	N	Wood	Factory Stain Wired Brushed Finish	Casement	-/D2.1	-/D2.1	-/D2.1	-/D2.1	2W2H	-	1		,			Dual Pane	-		Millworks Etc., Inc.	
(W222)	Bedroom 2	2'-6"	4'-0"	N	Wood	Factory Stain Wired Brushed Finish	Casement	-/D2.1	-/D2.1	-/D2.1	-/D2.1	2W2H	-	2		•			Dual Pane	-		Millworks Etc., Inc.	
(W223)	Bath 3	2'-0"	2'-0"	н	Wood	Factory Stain Wired Brushed Finish	Casement	-/D2.1	-/D2.1	-/D2.1	-/D2.1	2W2H	-	1		-			Dual Pane	Tempered		Millworks Etc., Inc.	\ \delta \delta \ \de
(W224)	Bedroom 3	2'-6"	4'-0"	N	Wood	Factory Stain Wired Brushed Finish	Casement	-/D2.1	-/D2.1	-/D2.1	-/D2.1	2W2H	-	1		- ]			Dual Pane	-		Millworks Etc., Inc.	]
(W225)	Laundry	2'-6"	4'-0"	N	Wood	Factory Stain Wired Brushed Finish	Interior Fixed	-/D2.1	-/D2.1	-/D2.1	-/D2.1	2W2H	-	1	-	-	-	-	-	-		Millworks Etc., Inc.	Casement

**Forest**Studio 23 Forest Avenue Siste 4 Fagens Bosek, 24 82651 849,487,9202 Nohilforestationis com www.forestationis.com

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## PICKUP RESIDENCE

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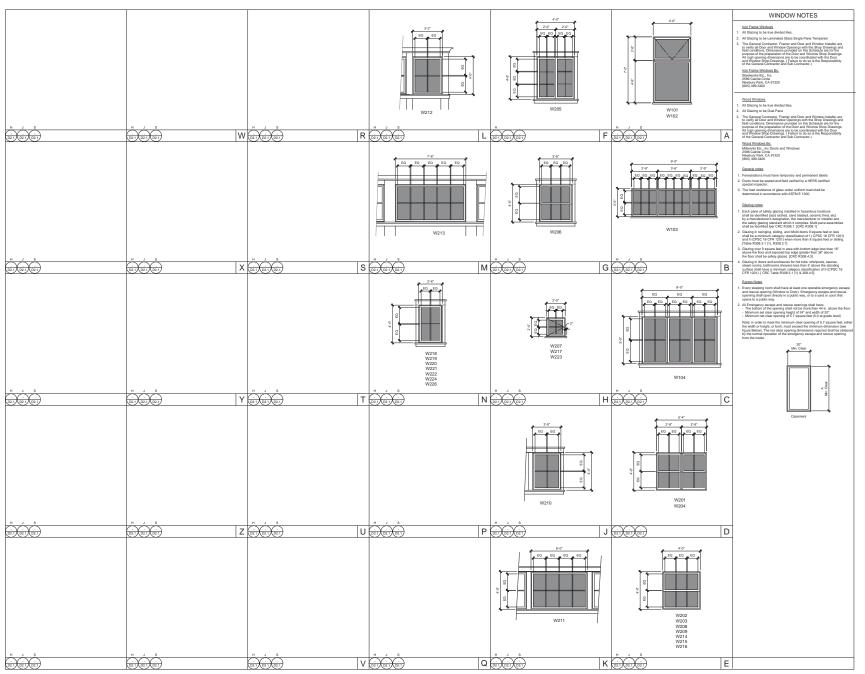
Lot 22, Tract 802

TELEPHONE: FAX:

PROJECT MANAGER: RR
PROJECT DESIGNER: BW
DRAWN BY:
PROJECT NUMBER: 18001
PROJECT CAD FILE: 18001-SCH11

WINDOW SCHEDULE

SCH1.1





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## PICKUP RESIDENCE

23 Harbor Island Newport Beach, CA 92663

Lot 22, Tract 802

TELEPHONE: FAX:

PROJECT MANAGER: RR
PROJECT DESIGNER: BW
DRAWN BY:
PROJECT NUMBER: 18001

PROJECT CAD FILE: 18001-SCH11

SHEET TITLE:

WINDOW TYPES

JEET NI IMPED

SCH1.2

LOT REFERENCE DATE:

ATE: 09-09

DOOR SCHEDULE													DOOR NOTES									
						DOOR			DESCRIPTION		FRAME		DETAIL	s	THRESH	DIVIDED	GLAZING	REMARKS	FENES	STRATION	MANUFACTURE	Wood Doors  1. Refer to Plans and Elevations for door Swing Direction
SYM	ROOM NAME	WIDTH	SIZE	THICKNESS	TYPE	QTY	MATERIAL	FINISH	DESCRIPTION	MATERIAL	FINISH	н	J	s	MATERIAL	LITES	GLAZING	REMARKS	U-VALUE	SHGC	MANUFACTURE	<ol><li>The General Contractor, Framer and Door and Window Installer are to verify all Door and Window Openings with the Shop Drawings and field conditions. Dimensions provided on this Schedule are for the</li></ol>
Main Le	el Doors								·													purpose of the preparation of the Door and Window Shop Drawings. All rogh opening dimensions are to be coordinated with the Door and Window Shop Drawings. (Failure to do so is the Responsibility of the Ganaral Contractor and Sub Contractor.)
D101	Entry Foyer	10'-3" 2'-0"	9'-6"	2"	А	1	Steel Frame	Factory Finish	U-Shaped Door / Fixed Window Assembly	Steel Frame	Factory Finish	-/D3.1	-/D3.1	-/D3.1	Stone	6W4H 1W4H	Double Glazing	Tempered	-	-	Steelworks, Etc, Inc.	Wood Doors By:
D102	Kitchen	16'-0"	8'-0"	2"	В	2	Steel Frame	Factory Finish	Bi-Fold (5 Panel) Unit / Passage / Bi-fold	Steel Frame	Factory Finish	-/D3.1	-/D3.1	-/D3.1	Stone	5W3H	Double Glazing	Tempered	-		Steelworks, Etc, Inc.	Milworks Etc., Inc Doors and Windows 2586 Calotte Circle Newbury Park, CA 91320 (805) 459-3400
D103	Covered Porch	16'-0"	8'-0"	2 1/4"	С	1	Wood	Factory Stain Wired Brushed Finish	Pocket (5 Panel) Louvered Doors	Wood	Factory Stain Wired Brushed Finish	-/D3.1	-/D3.1	-/D3.1	-	-		Tempered	-	-	Millworks, Etc, Inc.	Iron Frame Doors
D104	Living	12'-0"	8'-0"	2"	Е	1	Steel Frame	Factory Finish	Pocket (4 Panel)	Steel Frame	Factory Finish	-/D3.1	-/D3.1	-/D3.1	Stone	4W3H	Double Glazing	Tempered	-	-	Steelworks, Etc, Inc.	All Glazing to be true divided lites.     All Glazing to be Laminated Glass Single Pane Tempered
D106	Living	15'-7"	8'-0"	2"	В	1	Steel Frame	Factory Finish	Bi-Fold (5 Panel) Unit / Passage / Bi-fold	Steel Frame	Factory Finish	-/D3.1	-/D3.1	-/D3.1	Stone	5W3H	Double Glazing	Tempered	-		Steelworks, Etc, Inc.	Refer to Plans and Elevations for door Swing Direction     The General Contractor, Framer and Door and Window Installer are
D106	Pantry	2'-6"	8'-0"	2 1/4"	D	1	Wood	Factory Stain Wired Brushed Finish	S.C. Pocket	Wood	Factory Stain Wired Brushed Finish	-/D3.1	-/D3.1	-/D3.1	Stone	-	-	-	-	-	Millworks, Etc, Inc.	to verify all Door and Window Openings with the Shop Drawings and field conditions. Dimensions provided on this Schedule are for the number of the representation of the Door and Window Shop Drawings.
D107	Pantry	2'-8"	8'-0"	2"	F	1	Steel Frame	Factory Finish	Passage / Hopper Transom Above	Steel Frame	Factory Finish	-/D3.1	-/D3.1	-/D3.1	Stone	1W4H	Double Glazing	Tempered	-	-	Steelworks, Etc, Inc.	All rough opening dimensions are to be coordinated with the Door and Window Shop Drawings. (Failure to do so is the Responsibility of the General Contractor and Sub Contractor.)
D108	Powder	2'-4"	8'-0"	2 1/4"	D	1	Wood	Factory Stain Wired Brushed Finish	S.C.	Wood	Factory Stain Wired Brushed Finish	-/D3.1	-/D3.1	-/D3.1	-	-	-	-	-	-	Millworks, Etc, Inc.	Iron Frame Doors By: Steelworks Etc., Inc. 2586 Calcite Circle Newbury Park, CA 91320
D109	Coats	4'-8"	8'-0"	2 1/4"	G	1	Wood	Factory Stain Wired Brushed Finish	S.C Pair	Wood	Factory Stain Wired Brushed Finish	-/D3.1	-/D3.1	-/D3.1	-	-	-	-	-	-	Millworks, Etc, Inc.	Nowbury Park, CA 91320 (805) 499-3400
D110	Elevator	3'-0"	8'-0"	2 1/4"	D	1	Wood	Factory Stain Wired Brushed Finish	S.C Elevator	Wood	Factory Stain Wired Brushed Finish	-/D3.1	-/D3.1	-/D3.1	-	-	-	-	-	-	Millworks, Etc, Inc.	
D111	Natalie's Office	4'-0"	8'-0"	2 1/4"	Н	1	Wood	Factory Stain Wired Brushed Finish	S.C. Pocket	Wood	Factory Stain Wired Brushed Finish	-/D3.1	-/D3.1	-/D3.1	-	-	-	-	-		Millworks, Etc, Inc.	General notes
D112	Garage	3'-0"	8'-0"	2 1/4"	D	1	Wood	Factory Stain Wired Brushed Finish	S.C 20 Min. Self Closing & Self Latching	Wood	Factory Stain Wired Brushed Finish	-/D3.1	-/D3.1	-/D3.1	-	-	-	Self Closing and Self Latching	-	-	Millworks, Etc, Inc.	Fenestrations must have temporary and permanent labels  Ducts must be sealed and field verified by a HERS certified special inspector.
D113	Electrical Cabinet	5'-0"	8'-0"	2 1/4"	J	1	Wood	Factory Stain Wired Brushed Finish	S.C. / Pair / Louvered	Wood	Factory Stain Wired Brushed Finish	-/D3.1	-/D3.1	-/D3.1	Stone	-	-	-	-	-	Millworks, Etc, Inc.	Egress Notes
D114	Garage	3'-0"	7'-0"	2 1/4"	К	1	Wood	Factory Stain Wired Brushed Finish	S.C. / Louvered	Wood	Factory Stain Wired Brushed Finish	-/D3.1	-/D3.1	-/D3.1	Stone	-	•	-	-	-	Millworks, Etc, Inc.	Every sleeping room shall have at least one operable emergency escap and rescue opening (Window or Door). Emergency escape and rescue opening shall open directly in a public way, or to a yard or court that
D115	Storage Cabinet	5'-6"	8'-0"	2 1/4"	L	1	Wood	Factory Stain Wired Brushed Finish	S.C. / Pair / Louvered	Wood	Factory Stain Wired Brushed Finish	-/D3.1	-/D3.1	-/D3.1	Stone	-	-	-	-	-	Millworks, Etc, Inc.	opers to a public way.
D116	Garage	9'-0"	8'-0"	2 1/4"	М	3	Wood	Factory Stain Wired Brushed Finish	Garage / Sectional	Wood	Factory Stain Wired Brushed Finish	-/D3.1	-/D3.1	-/D3.1		-	-	-	-	-	Millworks, Etc, Inc.	The bottom of the opening shall not be more than 44 inches above the Minimum set clear opening height of 24" and width of 20".     Minimum net clear opening of 5.7 square feet (5.0 at grade level).
D117	Entry Gate	4'-3"	7'-6"	2 1/4"	N	1	Wood	Factory Stain Wired Brushed Finish	Gate	Wood	Factory Stain Wired Brushed Finish	-/D3.1	-/D3.1	-/D3.1	-	-	•	=	-	-	Millworks, Etc, Inc.	Note: in order to meet the minimum clear opening of 5.7 square feet, ei the width or height, or both, must exceed the minimum dimension (see figure Below). The net clear opening dimensions required shall be obta
D118	Sideyard Gate	3'-2"	5'-9"	2 1/4"	Р	1	Wood	Factory Stain Wired Brushed Finish	Gate	Wood	Factory Stain Wired Brushed Finish	-/D3.1	-/D3.1	-/D3.1	-	-	-	-	-	-	Millworks, Etc, Inc.	by the normal operation of the emergency escape and rescue opening from the inside.
Second	evel Doors																					
D201	Master Gallery	3'-0"	7'-0"	2 1/4"	D	1	Wood	Factory Stain Wired Brushed Finish	S.C.	Wood	Factory Stain Wired Brushed Finish	-/D3.1	-/D3.1	-/D3.1	-	-	•	=	-	-	Millworks, Etc, Inc.	
D202	Master Dressing	2'-6"	7'-0"	2 1/4"	D	1	Wood	Factory Stain Wired Brushed Finish	S.C. Pocket	Wood	Factory Stain Wired Brushed Finish	-/D3.1	-/D3.1	-/D3.1		-	•	-	-	-	Steelworks, Etc, Inc.	
D203	Master Walk-In	2'-6"	7'-0"	2 1/4"	D	1	Wood	Factory Stain Wired Brushed Finish	S.C.	Wood	Factory Stain Wired Brushed Finish	-/D3.1	-/D3.1	-/D3.1	-	-	•	=	-	-	Steelworks, Etc, Inc.	
D204	Master Bath - WC	2'-4"	7'-0"	2 1/4"	D	1	Wood	Factory Stain Wired Brushed Finish	S.C.	Wood	Factory Stain Wired Brushed Finish	-/D3.1	-/D3.1	-/D3.1	-	-	•	=	-	-	Steelworks, Etc, Inc.	
D206	Laundry	2'-8"	7'-0"	2 1/4"	D	1	Wood	Factory Stain Wired Brushed Finish	s.c.	Wood	Factory Stain Wired Brushed Finish	-/D3.1	-/D3.1	-/D3.1	-	-	-	-	-	-	Millworks, Etc, Inc.	
D206	Elevator	3'-0"	7'-0"	2 1/4"	D	1	Wood	Factory Stain Wired Brushed Finish	S.C. / Elevator	Wood	Factory Stain Wired Brushed Finish	-/D3.1	-/D3.1	-/D3.1	-	-	-	-	-	-	Millworks, Etc, Inc.	
D207	Upper Family	4'-6"	7'-0"	2 1/4"	Q	1	Wood	Factory Stain Wired Brushed Finish	S.C. Pocket	Wood	Factory Stain Wired Brushed Finish	-/D3.1	-/D3.1	-/D3.1	-	-	-	-	-	-	Millworks, Etc, Inc.	
D208	Bedroom 2	2'-6"	7'-0"	2 1/4"	D	1	Wood	Factory Stain Wired Brushed Finish	S.C.	Wood	Factory Stain Wired Brushed Finish	-/D3.1	-/D3.1	-/D3.1	-	-	-	-	-	-	Millworks, Etc, Inc.	
D209	Bedroom 2 Wic	2'-4"	7'-0"	2 1/4"	D	1	Wood	Factory Stain Wired Brushed Finish	S.C.	Wood	Factory Stain Wired Brushed Finish	-/D3.1	-/D3.1	-/D3.1	-	-	-	-	-	-	Millworks, Etc, Inc.	
D210	Bath 2	2'-4"	7'-0"	2 1/4"	D	1	Wood	Factory Stain Wired Brushed Finish	S.C.	Wood	Factory Stain Wired Brushed Finish	-/D3.1	-/D3.1	-/D3.1	-	-	•	-	-	-	Millworks, Etc, Inc.	
D211	Bedroom 3	2'-6"	7'-0"	2 1/4"	D	1	Wood	Factory Stain Wired Brushed Finish	S.C.	Wood	Factory Stain Wired Brushed Finish	-/D3.1	-/D3.1	-/D3.1	-	-	-	-	-	-	Millworks, Etc, Inc.	
D212	Bath 3	2'-4"	7'-0"	2 1/4"	D	1	Wood	Factory Stain Wired Brushed Finish	S.C.	Wood	Factory Stain Wired Brushed Finish	-/D3.1	-/D3.1	-/D3.1	-	-	-	-	-	-	Millworks, Etc, Inc.	
D213	Bedroom 3 Wic	2'-4"	7'-0"	2 1/4"	D	1	Wood	Factory Stain Wired Brushed Finish	S.C.	Wood	Factory Stain Wired Brushed Finish	-/D3.1	-/D3.1	-/D3.1	-	-	-	-	-	-	Millworks, Etc, Inc.	
D214	Bedroom 4	2'-6"	7'-0"	2 1/4"	D	1	Wood	Wired Brushed Finish	S.C.	Wood	Factory Stain Wired Brushed Finish	-/D3.1	-/D3.1	-/D3.1	-	-	-	-	-	-	Millworks, Etc, Inc.	
D215	Bedroom 4 Wic	2'-4"	7'-0"	2 1/4"	D	1	Wood	Wired Brushed Finish	S.C.	Wood	Factory Stain Wired Brushed Finish	-/D3.1	-/D3.1	-/D3.1	-	-	-	-	-	-	Millworks, Etc, Inc.	
D216	Bath 4	2'-4"	7'-0"	2 1/4"	D	1	Wood	Wired Brushed Finish	S.C. Pocket	Wood	Factory Stain Wired Brushed Finish	-/D3.1	-/D3.1	-/D3.1	-	-	-	-	-	-	Millworks, Etc, Inc.	<u> </u>



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## PICKUP RESIDENCE


23 Harbor Island Newport Beach, CA 92663

TELEPHONE:

DRAWN BY:
PROJECT NUMBER: 18001
PROJECT CAD FILE: 18001-SCH21

DOOR SCHEDULE

SCH2.1

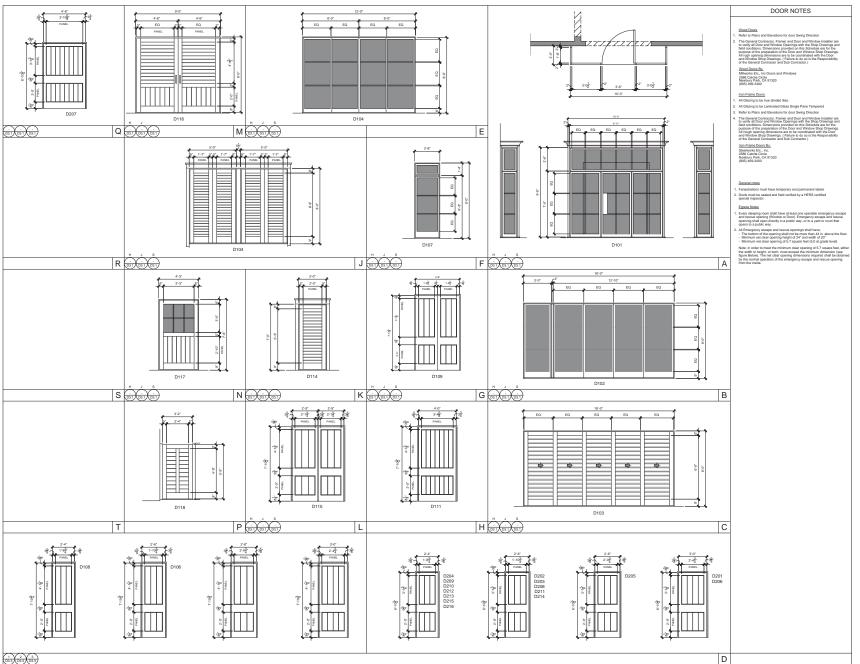

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PROJECT:

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Lot 22, Tract 802

TELEPHONE:


PROJECT MANAGER: RR
PROJECT DESIGNER: BW
DRAWN BY:
PROJECT NUMBER: 18001
PROJECT CAD FILE: 18001-SCH21

OUEST TITLS

DOOR TYPES

SCH2.2

OT RECEDENCE DATE: 00:00:10

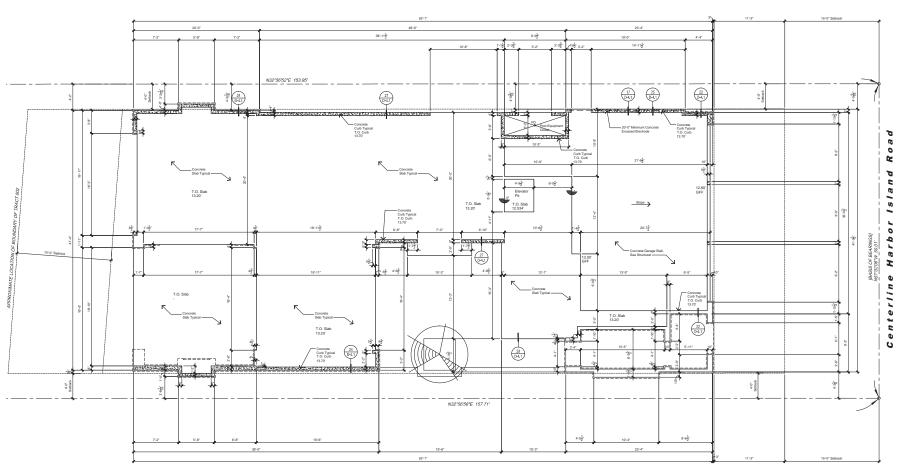

Slab Edge Plan

#### SLAB NOTES

- THIS ARCHITECTURAL FOUNDATION PLAN IS FOR DIMENSIONAL INFORMATION ONLY. THE CONTRACTOR SHALL REFER TO THE STRUCTURAL FOUNDATION PLAN FOR ALL STRUCTURAL REQUIREMENTS. THE CONTRACTOR SHALL NOTIFY THE ARCHITECT IF THERE IS ANY DISCREPANCY BETWEEN THE ARCHITECTURAL
- P. FOOTINGS SHALL BE EXAMINED AND CERTIFIED IN WRITING BY THE PROJECT SOIL / GEOLOGY ENGINEER PRIOR TO EMA INSPECTIONS AND PLACEMENT OF CONCRETE.
- VERIFY ALL INFORMATION REGARDING CONCRETE SLAB, FOUNDATION, AND RETAINING WALLS, WITH STRUCTURAL AND CIVIL ENGINEER'S DRAWINGS.
- REFER TO STRUCTURAL DRAWINGS FOR SHEAR WALLS AND HOLD DOWN LOCATIONS AND SIZES.
- DEPRESSED SLAB FOR MATERIAL THICKNESS REFER
  TO LEGEND.
- PROVIDE ELECTRICAL CONDUIT BELOW SLAB FOR FLOO OUTLETS, KITCHEN ISLAND OUTLETS AND APPLIANCES.
- SURVEYOUR TO FILE A CORNER RECORD OF SURVEY WITH THE OFFICE OF COUNTY SURVEYOR. EVIDENCE OF FILING SHALL BE SUBMITTED TO BUILDING INSPECTOR PRIOR TO FOUNDATION INSPECTION.

#### SLAB LEGEND

FINISH SLAB TO FINISH SLAB DIMENSION NOTE: REFER TO CIVIL DRAWINGS FOR ADDITIONAL SLAB ELEVATION INFORMATION

SLOPE TO DRAIN

ADDITIONAL SLAB ELEVATION INFORMATION

SLOPE TO DRAIN 1/8" PER FOOT U.N.O.

BUILDING DEPARTMENT SUBMITTAL: REVISIONS:



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Lot 22, Tract 802

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PROJECT MANAGER: RR
PROJECT DESIGNER: BW
DRAWN BY:
PROJECT NUMBER: 18001
PROJECT CAD FILE: 18001-PLN-FLOOR


SHEET TITLE:

SLAB EDGE PLAN

FET NUMBER

A1.1

OT REFERENCE DATE: 09,09,19

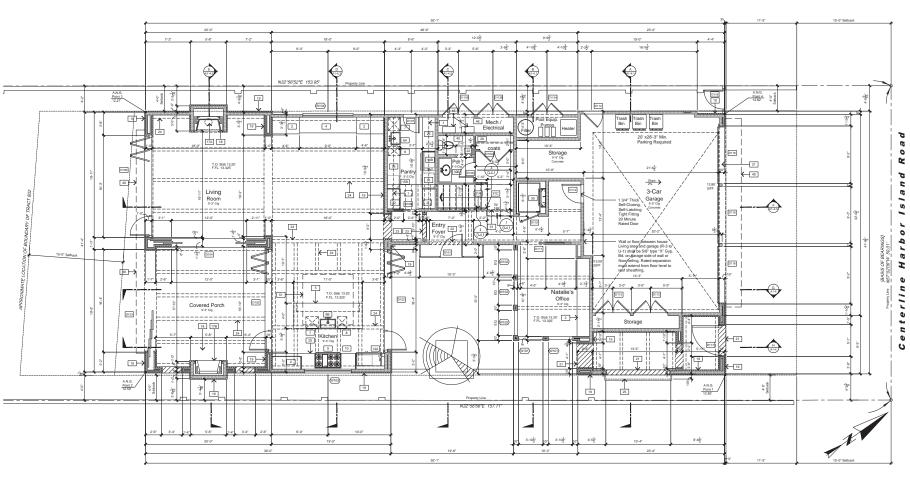

First Floor Plan SCALE: 1/4" = 1'-0"

#### FLOOR PLAN NOTES

- SMOKE DETECTORS SHALL BE INTERCONNECTED SLICH THAT AT THE ACTIVATION OF ONE ALARM WILL ACTIVATE ALL ALARMS AND DETECTORS SHALL BE "HADD WIRD" AND SHALL BE SOUTHED WITH A BATTERY BACK UP. CARBON MINOXODE DETCORES SHALL BE "HAD WIRD" AND SHALL BE COUNTY ON WITH A BATTERY BACK UP. CRED SHALL BE COUNTY ON WITH A BATTERY BACK UP. CRED SHALL BE COUNTY ON WITH A BATTERY BACK UP.
- ROOMS CONTAINING BATHTUBS, SHOWERS, SPAS AN SIMLAR FIXTURES SHALL BE PROVIDED WITH AN EXHAUST FAN WITH A MINBIUM CAPACITY OF 50 cm CBC 1203.4.2.1, CMC T4-4
- SHOWERS AND TUB / SHOWERS SHALL BE PROVIDED WITH PRESSURE BALANCE OR THERMOSTATIC MIXING VALVE CONTROLS. PER CPC.
- WATER CLOSETS SHALL USE NO MORE THAN 1.28 GALL OF WATER CORPT FLUEN LAVATORIES FALCETS NO MORE THAN 1.2 GPM AT 0.0 PS. NITCHEN NO MORE THAN 1.3 GPM AT 0.0 PS. NITCHEN FALCETS NO MORE THAN 1.8 GPM AT 0.0 PS. NITCHEN FALCETS NO MORE THAN 1.8 GPM AT 0.0 PS. NICHER SHOWER FLOED MORE NO THAN 2 GPM AT 0.0 PS. ALL PLIMBING FIXTURES SHALL BE COMPLYING WITH FLOW RATES IN CCC SECTION 4.303
- WHEN A SHOWER IS PROVIDED WITH MULTIPLE SHOWER HARD, THE SUM OF ROW TO ALL THE HEADS SHALL NOT EXCEED THE 29% REDUCED LIMIT, OR THE SHOWER SHALL NOT EXCEED THE 29% REDUCED LIMIT, OR THE SHOWER SHALL BE DESIGNED SO THAT ONLY ONE HEAD IS ON AT A TIME.
- LANDSCAPE IRRIGATION WATER USE SHALL HAVE WEATHER BASED CONTROLLERS, CGC 4:304.1
- PROVIDED WATER EFFICIENT LANDSCAPE IRRAGATION DESIGN WHERE POTABLE WATER USE DOES NOT EXCEED 65% OF THE ETG. (TIER 1) A MINIMUM OF 50% OF CONSTRUCTION WASTE IS TO BE RECYCLED. CGC 4-408.1
- PROVIDE FRE BLOCKS AND DRAFT STOPS IN THE WOODD FRAME FLOOR CONSTRUCTION CONTAINING CONCEALED SPACE ARCHEVER HERE IS USED ESTAGE AND SECOND CONCEAU FROM A C DURING CONSTRUCTION, ENDS OF DUCT OPENINGS ARE TO BE SEALED, AND MECHANICAL EQUIPMENT IS TO BE COVERED CGC 4.504.1

- PROVIDE NON-REMOVABLE BACKFLOW PREVENTION DEVICES AT ALL EXTERIOR HOSE BIBS. PER CPC. PROVIDE PRESSURE RELEF VALVE WITH DRAIN TO OUTSID AT WATER HEATERS DESCRIPTION
- PRIOR TO FINAL APPROVAL OF THE BUILDING LICENSED CONTRACTOR, ARCHITECT OR ENGINEER IN RESPOSBLI

BATHROOM FANS SHALL BE ENERGY STAR RATED, VENTED DIRECTLY TO THE OUTSIDE AND CONTROLLED BY A HUMBISTAT. CGC 4506.1

#### XX SYMBOL

- HANDRALS WITH A PERIMETER GREATER THAN 6.25 INCHES SHALL COMPLY WITH ROT1.7.8.3 Item 2.
- HANDRAILS SHALL BE CONTINUOUS WITHOUT INTERRUPTION BY NEWEL POST OR OTHER OBSTRUCTION, EXCEPT AT THE LANDING, VOLUTE OR TURNOUT ON LOWEST TREAD.

#### FLOOR PLAN KEY NOTES

CABINET(S) BUILT-IN MILLWORK KITCHEN ISLAND

24" FARM HOUSE SINK WITH GARBAGE DISPOSAL 30" FARM HOUSE SINK WITH GARBAGE DISPOSAL DISHWASHER AS SELECTED I TRASH RECYCLING BIN

SU-ZERO 24" UNDER COUNTER REI SELECTED BY OWNER

PERLICK 24" BEVERAGE CENTER

PERLICK WINE REFRIGERATOR

PERLICK 15" ICE MAKER

BRICK VENEER WOLF 48" GAS RANGE / OVEN AS SELECTED BY OWNER BRICK TRIM WOLF BUILT-IN OVEN AS SELECTED BY OWNER HEARTH OVEN W/ WARMING AS SELECTED BY OWNER WOLF MICROWAVE OVEN AS SELECTED BY OWNER SUB-ZERO PRO REFRIGERATOR SELECTED BY OWNER

FLAT DRYWALL OPENING SOLID SURFACE COUNTER TOP SHELF AND POLE DOUBLE SHELF AND POLE ELEVATOR MODEL LLT-950 BY-RESIDENTIAL ELEVATOR, INC.\* OR APPROVED EQUAL. ASME / ANSI ATT.1 NATIONAL SAFETY CODES FOR ELEVATORS. SECTION 5.3

PROVIDE 1 HOUR RATED SHAFT FOR ELEVATOR PER CBC SECTION 713

PREFABRICATED MODULAR FIREFLACE: 8Y: \*SOKERN MODEL BYAZ CAS BURNNO VENT-LESS FIREFBOX OR API EQUAL INVACCORDANCE WITH THE MANUFACTURER'S PUBLISHED INSTALLATI INSTRUCTIONS, AND APPLICABLE CODES.

PREFABRICATED METAL FIREPLACE: BY: SUPERIOR' MODEL DRT4036 GAS BURNING DIRECT VENT OR APPROVED EQUAL. HANDRAIL GUARDRAIL INSTALL IN ACCORDANCE WITH THE MANUFACTURER'S PUBLISHED INSTALLATION INSTRUCTIONS, AND APPLICABLE CODES NEWEL POST STAIR POST LAVATORY PEDESTAL SINK

FREE STANDING TUB BUILT-IN SOAP NICHE TEMPERED GLASS SHOWER DOOR

MEDICINE CABINET WATER CLOSET TO BE 30" MIN WIDE WITH 24" IN FRONT OF TOILET. LOW FLUSH TOILETS 1.28 GALLONS PER FLUSH

WASHER SPACE. PROVIDE RECESSED HOT AND COLD WATER BIBBS. PROVIDE FLOOR DRAIN.

DRYER SPACE PROVIDE DRYER VENT TO OUTSIDE AIR PER CMC

INSTANTANEOUS TANKLESS WATER HEATER .94 EF / 199,000 Blufty MECHANICAL EQUIPMENT AC UNIT REFER TO MECHANICAL PLANS ATTIC ACCESS LINE OF FLOOR ABOVE LINE OF FLOOR / ROOF BELOW CUSTOM FABRICATED OPERABLE STEEL FRAME GLASS SKYLIGHT

FLOOR DRAIN ROOF DRAIN STUCCO OVER CMU WALL REFER TO LANDSCAPE PLANS BRICK VENEER OVER CMU WALL REFER TO LANDSCAPE PLANS IPE WOOD GATE REFER TO LANDSCAPE PLANS

STONE PAVER OVER CONCRETE SLAB BASE REFER TO CIVIL AND LANDSCAPE PLANS

WALL LEGEND Area Tabulations LOW WALL

First Floor (Livable) 1,924 Sq. Ft. 170 Sq. Ft. 2 X 4 STUD WALL Covered Entry Galler 2 X 6 STUD WALL Covered Porch: 383 Sq. Ft. 2,985 Sq. Ft. 2 X 8 STUD WALL Total (Livable): 5,462 Sq. Ft. Pool Equipment: Total:

Total Proposed Building Area

815 Sq. Ft. 37 Sq. Ft. 43 Sq. Ft. 895 Sn Ft Total (Livable): Garage / Mechanical 5,462 Sq. Ft. 895 Sq. Ft. 6,357 Sq. Ft. 8,970 Sq. Ft.

ForestStudio agens Besek, SA 02651 549.497.0202 behilfbrestutuska ces

## rither GROUP

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## **PICKUP** RESIDENCE

23 Harbor Island Newport Beach, CA 92663

Lot 22, Tract 802

TELEPHONE: FAX:

PROJECT MANAGER: RR PROJECT DESIGNER: BW DRAWN BY: PRO IECT NI IMBER: 18001

PROJECT CAD FILE: 18001-PLN-FLOOR

FIRST FLOOR PLAN

A2.1

Second Floor Plan SCALE: 1/4" = 1'-0"

#### FLOOR PLAN NOTES

- SMOKE DETECTORS SHALL BE INTERCONNECTED SLICH THAT AT THE ACTIVATION OF ONE ALARM WILL ACTIVATE ALL ALARMS AND DETECTORS SHALL BE "HADD WIRD" AND SHALL BE SOUTHED WITH A BATTERY BACK UP. CARBON MINOXODE DETCORES SHALL BE "HAD WIRD" AND SHALL BE COUNTY ON WITH A BATTERY BACK UP. CRED SHALL BE COUNTY ON WITH A BATTERY BACK UP. CRED SHALL BE COUNTY ON WITH A BATTERY BACK UP.
- ROOMS CONTAINING BATHTUBS, SHOWERS, SPAS AN SIMLAR FIXTURES SHALL BE PROVIDED WITH AN EXHAUST FAN WITH A MINBIUM CAPACITY OF 50 cm CBC 1203.4.2.1, CMC T4-4
- SHOWERS AND TUB / SHOWERS SHALL BE PROVIDED WITH PRESSURE BALANCE OR THERMOSTATIC MIXING VALVE CONTROLS. PER CPC.
- WATER CLOSETS SHALL USE NO MORE THAN 1.28 GALL OF WATER CORPT FLUEN LAVATORIES FALCETS NO MORE THAN 1.2 GPM AT 0.0 PS. NITCHEN NO MORE THAN 1.3 GPM AT 0.0 PS. NITCHEN FALCETS NO MORE THAN 1.8 GPM AT 0.0 PS. NITCHEN FALCETS NO MORE THAN 1.8 GPM AT 0.0 PS. NICHER SHOWER FLOED MORE NO THAN 2 GPM AT 0.0 PS. ALL PLIMBING FIXTURES SHALL BE COMPLYING WITH FLOW RATES IN CCC SECTION 4.303
- WHEN A SHOWER IS PROVIDED WITH MULTIPLE SHOWER HARD, THE SUM OF ROW TO ALL THE HEADS SHALL NOT EXCEED THE 29% REDUCED LIMIT, OR THE SHOWER SHALL NOT EXCEED THE 29% REDUCED LIMIT, OR THE SHOWER SHALL BE DESIGNED SO THAT ONLY ONE HEAD IS ON AT A TIME.
- LANDSCAPE IRRIGATION WATER USE SHALL HAVE WEATHER BASED CONTROLLERS, CGC 4:304.1
- PROVIDED WATER EFFICIENT LANDSCAPE IRRAGATION DESIGN WHERE POTABLE WATER USE DOES NOT EXCEED 65% OF THE ETG. (TIER 1)
- A MINIMUM OF 50% OF CONSTRUCTION WASTE IS TO BE RECYCLED. CGC 4-408.1
- DURING CONSTRUCTION, ENDS OF DUCT OPENINGS ARE TO BE SEALED, AND MECHANICAL EQUIPMENT IS TO BE COVERED CGC 4.504.1

PRIOR TO FINAL APPROVAL OF THE BUILDING LICENSED CONTRACTOR, ARCHITECT OR ENGINEER IN RESPOSBL

- BATHROOM FANS SHALL BE ENERGY STAR RATED, VENTED DIRECTLY TO THE OUTSIDE AND CONTROLLED BY A HUMIDISTAT. CGC 4.506.1
- PROVIDE NON-REMOVABLE BACKFLOW PREVENTION DEVICES AT ALL EXTERIOR HOSE BIBS. PER CPC. PROVIDE PRESSURE RELEF VALVE WITH DRAIN TO OUTSID AT WATER HEATERS, PER CPC.
  - - HANDRAILS WITH A PERIMETER GREATER THAN 625 INCHES SHALL COMPLY WITH R011.7.8.3 Isom 2.
    - HANDRAILS SHALL BE CONTINUOUS WITHOUT INTERRUPTION BY NEWEL POST OR OTHER OBSTRUCTION, EXCEPT AT THE LANDING, VOLUTE OR TURNOUT ON LOWEST TREAD.

#### FLOOR PLAN KEY NOTES

XX SYMBOL

CABINET(S) BUILT-IN MILLWORK KITCHEN ISLAND 24" FARM HOUSE SINK WITH GARBAGE DISPOSAL

30" FARM HOUSE SINK WITH GARBAGE DISPOSAL DISHWASHER AS SELECTED I TRASH RECYCLING BIN

WOLF 48" GAS RANGE / OVEN AS SELECTED BY OWNER WOLF BUILT-IN OVEN AS SELECTED BY OWNER HEARTH OVEN W/ WARMING AS SELECTED BY OWNER WOLF MICROWAVE OVEN AS SELECTED BY OWNER

PERLICK 24" BEVERAGE CENTER

PERLICK 15" ICE MAKER

BRICK VENEER BRICK TRIM FLAT DRYWALL OPENING SOLID SURFACE COUNTER TO SUB-ZERO PRO REFRIGERATOR SELECTED BY OWNER SHELF AND POLE SU-ZERO 24" UNDER COUNTER REI SELECTED BY OWNER DOUBLE SHELF AND POLE PERLICK WINE REFRIGERATOR ELEVATOR MODEL LLT-950 BY-RESIDENTIAL ELEVATOR, INC.\* OR APPROVED EQUAL. ASME / ANSI ATT.1 NATIONAL SAFETY CODES FOR ELEVATORS. SECTION 5.3

PROVIDE 1 HOUR RATED SHAFT FOR ELEVATOR PER CBC SECTION 713

PREFABRICATED METAL FIREPLACE: BY: SUPERIOR' MODEL DRT4036 GAS BURNING DIRECT VENT OR APPROVED EQUAL. HANDRAIL GUARDRAIL INSTALL IN ACCORDANCE WITH THE MANUFACTURER'S PUBLISHED INSTALLATION INSTRUCTIONS, AND APPLICABLE CODES NEWEL POST STAIR POST PREFABRICATED MODULAR FIREFLACE: 8Y: \*SOKERN MODEL BYAZ CAS BURNNO VENT-LESS FIREFBOX OR API EQUAL INVACCORDANCE WITH THE MANUFACTURER'S PUBLISHED INSTALLATI INSTRUCTIONS, AND APPLICABLE CODES. LAVATORY PEDESTAL SINK

FREE STANDING TUB BUILT-IN SOAP NICHE TEMPERED GLASS SHOWER DOOR

MEDICINE CABINET WATER CLOSET TO BE 30" MIN WIDE WITH 24" IN FRONT OF TOLET. LOW FLUSH TOILETS 1.28 GALLONS PER FLUSH

WASHER SPACE. PROVIDE RECESSED HOT AND COLD WATER BIBBS. PROVIDE FLOOR DRAIN. DRYER SPACE PROVIDE DRYER VENT TO OUTSIDE AIR PER CMC

## WALL LEGEND

INSTANTANEOUS TANKLESS WATER HEATER .94 EF / 199,000 Blufty

MECHANICAL EQUIPMENT

ATTIC ACCESS

FLOOR DRAIN

AC UNIT REFER TO MECHANICAL PLANS

LINE OF FLOOR ABOVE LINE OF FLOOR / ROOF BELOW

STUCCO OVER CMU WALL REFER TO LANDSCAPE PLANS

BRICK VENEER OVER CMU WALL REFER TO LANDSCAPE PLANS

STONE PAVER OVER CONCRETE SLAB BASE REFER TO CIVIL AND LANDSCAPE PLANS

IPE WOOD GATE REFER TO LANDSCAPE PLANS

LOW WALL 2 X 4 STUD WALL 2 X 6 STUD WALL 2 X 8 STUD WALL

Area Tabulations First Floor (Livable) 1,924 Sq. Ft. 170 Sq. Ft. Covered Entry Galler Covered Porch: 383 Sq. Ft. 2,985 Sq. Ft. Total (Livable): 5,462 Sq. Ft. 815 Sq. Ft. 37 Sq. Ft. 43 Sq. Ft. Pool Equipment: Total: 895 Sn Ft Total (Livable): Garage / Mechanical 5,462 Sq. Ft. 895 Sq. Ft.

Total Proposed Building Area 6,357 Sq. Ft.

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## **PICKUP** RESIDENCE

23 Harbor Island Newport Beach, CA 92663

Lot 22, Tract 802


TELEPHONE: FAX:

PROJECT MANAGER: RR PROJECT DESIGNER: BW DRAWN BY: PRO IECT NI IMBER: 18001 PROJECT CAD FILE: 18001-PLN-FLOOR

SECOND FLOOR PLAN

A2.2

8,970 Sq. Ft.

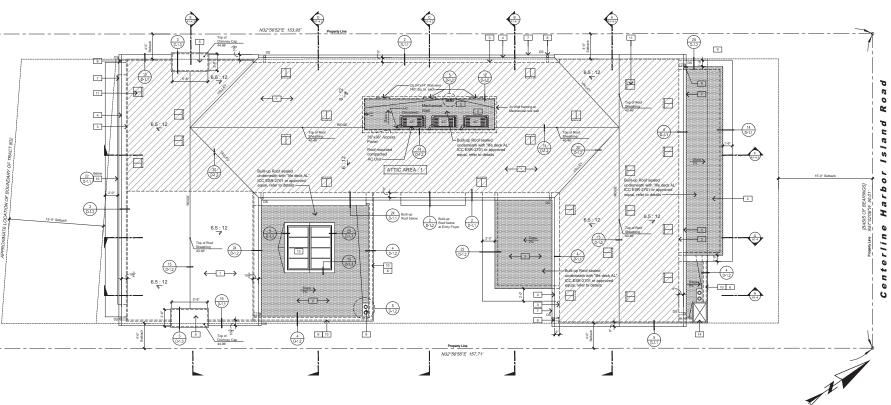

SCALE: 1/4" = 1'-0" FAX:

> PROJECT MANAGER: RR PROJECT DESIGNER: BW DRAWN BY: PROJECT NUMBER: 18001

ROOF

PLAN

A3.1

Roof Plan

ATTIC AREA TABULATIONS

14.05 SQ. FT. 2,024 SQ. IN. VENTILATION PROVIDED: (23) O'HAGIN ROOF VENT(S) 72.0 SQ. IN. EA. = 1,656 SQ. IN. 140.0 SQ. IN. EA. = 420 SQ. IN. TOTAL = 2,076 SQ. IN.

ATTIC VENT OPENINGS SHALL HAVE CORROSION-RESISTANT WIRE MESH OR OTHER APPROVED MATERIAL WITH 1/16" INCH MINIMUM AND 1/8" INCH

#### ROOF PLAN NOTES

- SPRAY FOAM INSULATION SHALL BE USED FO ALL RAFTER BAYS IN VOLUME CEILINGS

## ROOF KEY NOTES

- XX SYMBOL

  - BUILT-UP (CLASS 'A') MODIFIED BITUMEN RO
  - 3 LINE OF BUILDING BELOW
  - CHIMNEY CAP, REFER TO DETAIL 3 /D-1.3
  - COPPER METAL GUTTER 8 COPPER METAL DOWNSPOUT

#### ROOF LEGEND

INDICATES ROOF PITCH AND DIRECTION OF ROOF SLOPE

BY: HUNDERSKD PRODUCTS, IN SEE DETAIL 4 / D1.2 ICC - ES REPORT PMG-1212 CONNECTED TO SITE DRAINAGE S OVERFLOW TO BE PIPED SEPARA\*

13 MANUFACTURED ALUMINUM SKYLIGHT BY BABCOCK - DAVIS' MODEL # BA-3630

12 BUILT-UP CRICKET 2% MIN

14 DECORATIVE LIGHT FIXTURE

HATCHING INDICATES ROOF ATTIC SPACE

HATCHING INDICATES BUILT-UP ROOFING, REFER TO DETAILS

x:12

nte 0 C

**PICKUP** RESIDENCE

ForestStudio

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503 32ND STREET, SUITE 130 NEWPORT BEACH, CA 92663

TELEPHONE: (949) 999-3255 FAX: (9-


rither GROUP

23 Harbor Island Newport Beach, CA 92663

Lot 22, Tract 802

TELEPHONE:

PROJECT CAD FILE: 18001-PLN-FLOOR

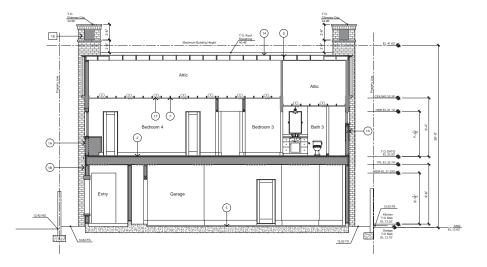

Section "A"



#### SECTION NOTES

- 1 REFER TO STRUCTURAL ENGI 2 DETAILS REFERENCED IN THESE DRAWINGS ARE FOR CLARIFICATION OF THE ARCHITECTURAL DESIGN
- INTENT. REFER TO ENGINEERING DRAWINGS PREPARED BY OTHERS FOR DETAILED INFORMATION.

#### SECTION KEY NOTES

XX SYMBOL

- (20) SYMBOL

  TYPICAL EXTERIOR WALL ASSEMBLY,

  A WOOD CEDAS SHINDLE SIDING.

  BRICK YNERSE (WHERE COCURS)

  C. WIRE LATH OVER MIN. TWO LAYERS GRADE D.

  PLYWOOD SHEATHING OS HEAR PANELS

  (WHERE INDICATED).

  2. ZWALL FRANNO WITH INSULATION PER T-54.

  F. EQUIRED MINALED MAD (TYPE X' WHERE

  REQUIRED.

- 2 TYPICAL FLOOR/CEILING ASSEMBLY: A. FLOOR FINISH SEE PLAN.
- A. FLOOR FINISH SEE PLAN.

  G. GYPCSETS HEATHING MATERIAL GLUED AND SCREWED, THICKNESS PER STRUCT. ENGINEER.

  D. FLOOR JOISTS PER STRUCT. ENGINEER.

  E. 22 WIOD FURRING WHERE OCCURS).

  F. GYPSUM WALLBOARD (TYPE 'X' WHERE OCCURS).
- 3 TOPICAL STRAIN ASSEMBLY.
  A HARDSHAL BY TAXL, ST MAN ABOVE
  A HARDSHAL BY TAXL, ST MAN ABOVE
  A FRIENDAM THE PROPAGATION
  CONTRAINED BY TAXLED BY TA

- 5 CONCRETE GARAGE SLAB. SEE STRUCTURAL DWGS.
- 6 2x WOOD FRAMING
- 7 2x CEILING JOIST 8 WOOD I-JOISTS. SEE STRUCTURAL DWGS
- 9 WOOD CONVENTIONAL FRAMED ROOF. SEE STRUCTURAL DRAWINGS
- 10 EXPOSED TEAK RAFTER TAIL
- 11 EXPOSED TEAK CORBEL BEAM 12 TEAK WINDOW BAY DETAILING
- 13 BUILT-UP WOOD EAVES AND RAKES
- 14 PLYWOOD ROOF SHEATHING
- 15 PLYWOOD DECK SHEATHING
- 16 BUILT-UP ("CLASS A") MODIFIED BITUMEN ROOFING OVER EXTERIOR GRADE ROOF SHEATHING 1/4": 12 MINIMUM SLOPE U.N.O.
- 18 THIN BRICK VENEER PAINTED WHITE

#### ELEVATION KEY NOTES

- 1 WOOD SHINGLE ROOF 2 METAL ROOF 3 BUILT-UP 'CLASS A' ROOF
- 4 GUTTER / DOWNSPOUT
- 5 BUILT-UP WOOD EAVES A
- 6
- 7 WOOD TRIM DETAILING PAI
- 9 TEAK CORBEL
- 10 TEAK RAFTER TALS
  11 WOOD ENTRY DOOR
- 12 WOOD DOOR / WINDOW
- 13 STEEL DOOR / WINDOW
- 14 WOOD GARAGE DOOR
- 15 WOOD GATE 16 WOOD SHUTTER
- 17
- 13 CHIMNEY CAP
- 19 PLANTER WALL REFER TO LANDSCAPE PLANS
- 20 DECORATIVE LIGHT FIXTURE 21 DECORATIVE COPPER GABLE VENT
- 22 BUILDING ADDRESS
- 23 SKYLIGHT
- REFER TO SHEETS T24-1a & T24-1b FOR CF1R FORMS AND COMPLIANCE INFORMATION

	INSU	LATION SC	HEDULE		
Construction Name	Surface Type	Construction Type	Framing	Total Cavity R-Value	Winter Design U-Value
Garage Ceiling	Floor / Ceiling	Wood Framed Ceiling	16" TJI @ 16" o/c	None	0.332
Garage Exterior Wall	Exterior Walls	Wood Framed Wall	2x6 @ 16" o/c	None	0.347
R-30 Roof	Volume Ceilings	Wood Framed Ceiling	2x10 @ 16" o/c	R-30	0.036
R-22 Roof	Volume Ceilings	Wood Framed Ceiling	2x4 @ 16" o/c	R-22	0.056
R-21 Wall	Exterior Walls	Wood Framed Wall	2x6 @ 16" o/c	R-21	0.069
R-21 Wall 1	Interior Walls	Wood Framed Wall	2x6 @ 16" o/c	R-21	0.064
Attic / Roof / Zone 2	Attic Roofs	Wood Framed Ceiling	2x4 Truss @ 24" o/c	R-30	0.040
R-30 Roof HPA	Ceilings Below Attic	Wood Framed Ceiling	2x6 @ 24" o/c	None	0.478

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### PICKUP RESIDENCE

23 Harbor Island Newport Beach, CA 92663

Lot 22, Tract 802

TELEPHONE:

FAX:


PROJECT MANAGER: RR PROJECT DESIGNER: BW

DRAWN BY: PROJECT NUMBER: 18001 PROJECT CAD FILE: 18001-PLN-ELEV

BUILDING SECTIONS

A4.1



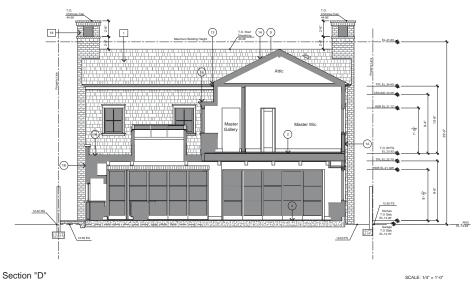

#### SECTION NOTES

- 2 DETAILS REFERENCED IN THESE DRAWINGS ARE FOR CLARIFICATION OF THE ARCHITECTURAL DESIGN INTENT. REFER TO ENGINEERING DRAWINGS PREPARED BY OTHERS FOR DETAILED INFORMATION.

#### SECTION KEY NOTES

XX SYMBOL

- (20) SYMBOL

  TYPICAL EXTERIOR WALL ASSEMBLY,

  A WOOD CEDAS SHINDLE SIDING.

  BRICK YNERSE (WHERE COCURS)

  C. WIRE LATH OVER MIN. TWO LAYERS GRADE D.

  PLYWOOD SHEATHING OS HEAR PANELS

  (WHERE INDICATED).

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  REQUIRED.

- 2 TYPICAL FLOOR, CELING ASSEMBLY:
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  C FLOOR SHEATHING MATERIAL GLUED AND SCREWED, THICKNESS PER STRUCT, ENGINEER.
  FLOOR GUISTS PER STRUCT; ENGINEER.
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- 5 CONCRETE GARAGE SLAB. SEE STRUCTURAL DWGS.
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- 16 BUILT-UP ("CLASS A") MODIFIED BITUMEN ROOFING OVER EXTERIOR GRADE ROOF SHEATHING 1/4": 12 MINIMUM SLOPE U.N.O.
- 18 THIN BRICK VENEER PAINTED WHIT

#### ELEVATION KEY NOTES

- 1 WOOD SHINGLE ROOF 2 METAL ROOF 3 BUILT-UP 'CLASS A' ROOF
- 4 GUTTER / DOWNSPOUT
- S BUILT-UP WOOD EAVES 6
- 7 WOOD TRIM DETAILING PA
- 9 TEAK CORBEL
- 10 TEAK RAFTER TALS
  11 WOOD ENTRY DOOR
- 12 WOOD DOOR / WINDOW
- 13 STEEL DOOR / WINDOW
- 14 WOOD GARAGE DOOR
- 15 WOOD GATE
  16 WOOD SHUTTER
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- 13 CHIMNEY CAP
- 19 PLANTER WALL REFER TO LANDSCAPE PLANS
- 20 DECORATIVE LIGHT FIXTURE 21 DECORATIVE COPPER GABLE VENT
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- 23 SKYLIGHT
- REFER TO SHEETS T24-1a & T24-1b FOR CF1R FORMS AND COMPLIANCE INFORMATION

Construction Name	Surface Type	Construction Type	Framing	Total Cavity R-Value	Winter D
Garage Ceiling	Floor / Ceiling	Wood Framed Ceiling	16" TJI @ 16" o/c	None	0.33
Garage Exterior Wall	Exterior Walls	Wood Framed Wall	2x6 @ 16" o/c	None	0.34
R-30 Roof	Volume Ceilings	Wood Framed Ceiling	2x10 @ 16° o/c	R-30	0.03
R-22 Roof	Volume Ceilings	Wood Framed Ceiling	2x4 @ 16" o/c	R-22	0.05
R-21 Wall	Exterior Walls	Wood Framed Wall	2x6 @ 16" o/c	R-21	0.068
R-21 Wall 1	Interior Walls	Wood Framed Wall	2x6 @ 16" o/c	R-21	0.06
Attic / Roof / Zone 2	Attic Roofs	Wood Framed Ceiling	2x4 Truss @ 24" o/c	R-30	0.04
R-30 Roof HPA	Ceilings Below Attic	Wood Framed Ceiling	2x6 @ 24" o/c	None	0.47

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### PICKUP RESIDENCE

23 Harbor Island Newport Beach, CA 92663

Lot 22, Tract 802


TELEPHONE: FAX:

PROJECT MANAGER: RR PROJECT DESIGNER: BW

DRAWN BY: PROJECT NUMBER: 18001 PROJECT CAD FILE: 18001-PLN-ELEV

BUILDING SECTIONS


A4.2

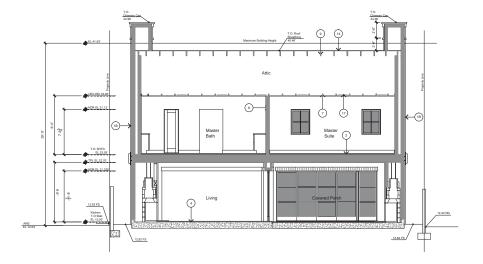

REFER TO SHEETS T24-1a & T24-1b FOR CF1R FORMS AND COMPLIANCE INFORMATION

	INSU	LATION SC	HEDULE		
Construction Name	Surface Type	Construction Type	Framing	Total Cavity R-Value	Winter Design U-Value
Garage Ceiling	Floor / Ceiling	Wood Framed Ceiling	16" TJI @ 16" o/c	None	0.332
Garage Exterior Wall	Exterior Walls	Wood Framed Wall	2x6 @ 16" o/c	None	0.347
R-30 Roof	Volume Ceilings	Wood Framed Ceiling	2x10 @ 16" o/c	R-30	0.036
R-22 Roof	Volume Ceilings	Wood Framed Ceiling	2x4 @ 16" o/c	R-22	0.056
R-21 Wall	Exterior Walls	Wood Framed Wall	2x6 @ 16" o/c	R-21	0.069
R-21 Wall 1	Interior Walls	Wood Framed Wall	2x6 @ 16" o/c	R-21	0.064
Attic / Roof / Zone 2	Attic Roofs	Wood Framed Ceiling	2x4 Truss @ 24° o/c	R-30	0.040
R-30 Roof HPA	Ceilings Below Attic	Wood Framed Ceiling	2x6 @ 24" o/c	None	0.478

Section "E"

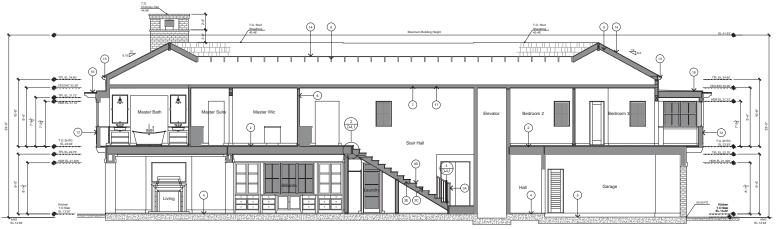

Section "F"

#### SECTION NOTES 1 REFER TO STRUCTURAL ENGINEER DRAWINGS

- 2 DETAILS REFERENCED IN THESE DRAWINGS ARE FOR CLARIFICATION OF THE ARCHITECTURAL DESIGN INTENT. REFER TO ENGINEERING DRAWINGS PREPARED BY OTHERS FOR DETAILED INFORMATION.

#### SECTION KEY NOTES

- SYMBOL

  1 TYPOLE EXTERIOR WALL ASSEMBLY:
  A WOOD CEEDAS SHINGLE SIDNO.
  A WOOD CEEDAS SHINGLE SIDNO.
  C WAS LITH OVER WAN TWO LAYERS GRADE D
  BELLEDOD POPERSON OF SHEAR PARKELS
  (WHITE ROCATED).
  E ZYMBUL RYMBU SHINGLATON FOR TAL
  RECOURTD).
  THOUGHT STANDARD SHIP SHEAR PARKELS
  (WHITE ROCATED).
  E ZYMBUL RYMBU SHINGLATON FOR TAL
  RECOURTD).
  THOUGHT SHIP SHIP SHIP SHIP SHIP SHIP

  TYPOLA TOPORTS—

- 2 TYPICAL FLORCELING ASSEMBLY:
  A. FLOOR FINSH-1 SEE PLAN.
  C. SUBFLOOR SHEATTHING MATERIAL GLUED AND
  SCREWED, THOMESS PER STRUCT, ENGINEER.
  F. CONCUSTS PER STRUCT; ENGINEER.
  F. GYPSUM WALLBOARD (TYPE "X" WHERE
  OCCURS).
- 3 TYPICAL STAN ASSEMBLY
  A MACROAL B SP MAY, SP MA ABOVE
  A MACROAL B SP MAY, SP MA ABOVE
  A MACROAL B SP MAY, SP MA ABOVE
  B THE MACROAL SP MAY ABOVE THE MACRO THE MACRO

- 5 CONCRETE GARAGE SLAB. SEE STRUCTURAL DWGS
- 6 2x WOOD FRAMING
- 7 2x CEILING JOIST
- 8 WOOD I-JOISTS. SEE STRUCTURAL DWGS
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- 18 THIN BRICK VENEER PAINTED WHITE

#### ELEVATION KEY NOTES

_		
1	WOOD SHINGLE RO	or
$\neg$		

2 METAL ROOF
3 BUILT-UP 'CLASS A' ROOF

4 GUTTER / DOWNSPOUT

5 BUILT-UP WOOD EAVES AND RAKES

6 WOOD CEDAR SHINGLE SIDIN

7 WOOD TRIM DETAILING PAINTED WHITE

B TEAK WINDOW BAY DETAILING

9 TEAK CORBEL 10 TEAK RAFTER TAILS

11 WOOD ENTRY DOOR

12 WOOD DOOR / WINDOW 13 STEEL DOOR / WINDOW 14 WOOD GARAGE DOOR

15 WOOD GATE 16 WOOD SHUTTER

17 THIN BRICK VENEER 18 CHIMNEY CAP

19 PLANTER WALL - REFER TO LANDSCAPE PLANS 20 DECORATIVE LIGHT FIXTURE

21 DECORATIVE COPPER GABLE VENT 22 BUILDING ADDRESS

23 SKYLIGHT



#### rither GROUP

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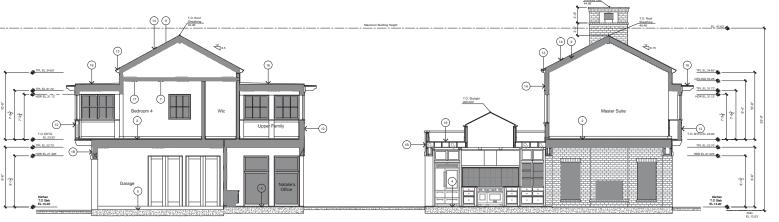
Lot 22, Tract 802

TELEPHONE: FAX:

PROJECT MANAGER: RR PROJECT DESIGNER: BW DRAWN BY: PROJECT NUMBER: 18001 PROJECT CAD FILE: 18001-PLN-ELEV

BUILDING SECTIONS

A4.3



Section "G"

INSULATION SCHEDULE 2x6 @ 16" o/c R-21 Wall 1 Interior Walls Attic Roofs 2x6 @ 16" o/c R-21 R-30

REFER TO SHEETS T24-1a & T24-1b FOR CF1R FORMS AND COMPLIANCE INFORMATIO



Section "H"

#### SECTION NOTES

- DETAILS REFERENCED IN THESE DRAWINGS ARE FOR CLARIFICATION OF THE ARCHITECTURAL DESIGN FOR CLAMINICATION OF THE ARCHITECTURAL DESIGN INTENT. REFER TO ENGINEERING DRAWINGS PREPARED BY OTHERS FOR DETAILED INFORMATION.

#### SECTION KEY NOTES

XX SYMBOL

- TYPICAL EXTERIOR WALL ASSEMBLY.

  A. WODO CEDAS SHINICE SIDNEY.

  D. BIGUCY WAREN (WHERE COCURS)

  C. WIRE LATH OVER MIN TWO LAYERS GRADE D.

  PLYWOOD SHEATHING OR SHEAP PANELS
  (WHERE INDICATED).

  Z. WALL FRAMING WITH INSULATION PER T-24.

  F. ZWALL FRAMING WITH INSULATION PER T-24.

  REQUIRED.
- 2 TYPICAL FLOOR/CEILING ASSEMBLY: A. FLOOR FINISH SEE PLAN.
- A. FLOOR FINISH SEE PLAN.

  8. GYPCRES HEATHING MATERIAL GLUED AND SCREWED, THICKNESS PER STRUCT. ENGINEER.

  D. FLOOR JUISTS PER STRUCT. ENGINEER.

  2. 2W WOOD FURRING (WHERE OCCURS).

  F. GYPSUM WALLBOARD (TYPE "X" WHERE OCCURS).
- 3 TYPICAL STAR ASSEMBLY:
  A HANGRAL B SYMAX, SYMIN ABOVE
  B FRIEND HATGEL PER PLAN.
  C SYMIN HOSERS
  C SYMAX HOSERS
  C SYMAX HOSERS
  C SYMIN HOSERS

- STRUCTURAL DRAWINGS.

  1/2" GYPSIJM BOARD MIN. AT WALLS AND CEILINGS OF ALL USABLE SPACE UNDER STAIRS.

  I. GUARDRAIL @ 42" MIN. ABOVE FINISH FLOOF
- CONCRETE GARAGE SLAB. SEE STRUCTURAL DWG
- 2x WOOD FRAMING
- 2x CEILING JOIST WOOD I-JOISTS. SEE STRUCTURAL DWGS

- 10 EXPOSED TEAK RAFTER TAIL
- 11 EXPOSED TEAK CORBEL BEAM
- 13 BUILT-UP WOOD EAVES AND RAKES
- 14 PLYWOOD ROOF SHEATHING
- 15 PLYWOOD DECK SHEATHING
- 16 BUILT-UP ("CLASS A") MODIFIED BITUMEN ROOFING OVER EXTERIOR GRADE ROOF SHEATHING 1/4": 12 MINIMUM SLOPE U.N.O.
- 18 THIN BRICK VENEER PAINTED WHIT

#### ELEVATION KEY NOTES

- 1 WOOD SHINGLE ROOF
- 2 METAL ROOF
  3 BUILT-UP 'CLASS A' ROOF
- 4 GUTTER / DOWNSPOUT

  5 BUILT-UP WOOD EAVES AN
- 6 WOOD CEDAR SHINGLE S
- 7 WOOD TRIM DETAILING PAINTE 8 TEAK WINDOW BAY DETAILING
- 9 TEAK CORBEL
- 10 TEAK RAFTER TAILS 11 WOOD ENTRY DOOR
- 12 WOOD DOOR / WINDOW
- 13 STEEL DOOR / WINDOW 14 WOOD GARAGE DOOR
- 15 WOOD GATE
- 16 WOOD SHUTTER
- 17 THIN BRICK VENEE 13 CHIMNEY CAP
- 19 PLANTER WALL REFER TO LAN
- 20 DECORATIVE LIGHT FIXTURE
- 21 DECORATIVE COPPER GABLE VENT
- 22 BUILDING ADDRESS 23 SKYLIGHT

**Forest**Studio agens Basek, SA 02651

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### **PICKUP** RESIDENCE

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Lot 22, Tract 802

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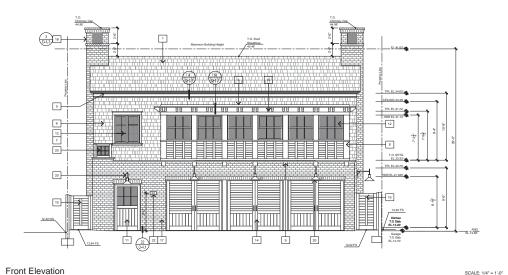
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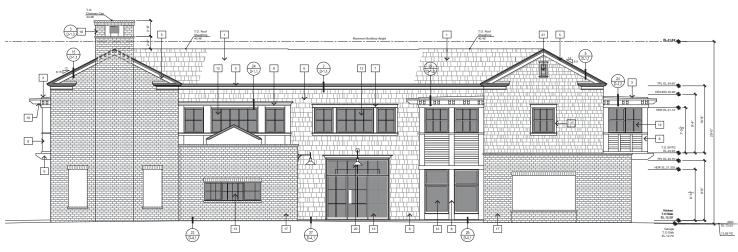
PROJECT NUMBER: 18001 PROJECT CAD FILE: 18001-PLN-ELEV

BUILDING SECTIONS

A4.4

36





### **ELEVATION NOTES**

THE MINIMUM REQUIRED TOP OF SLAB ELEVATION FOR INTERIOR LIVING AREAS OF ALL NEW STRUCTURES SHALL BE AT LEAST 9.00 (NAVD 88). THE HEIGHT OF A PRINCIPAL STRUCTURE SHALL BE MEASURED FROM THIMIMUM REQUIRED TOP OF SLAB ELEVATION.

BUILT-UP EAVES, AND RAKES:

GARAGE DOORS & GATES:

SCALE: 1/4" = 1'-0"

SCALE: 1/4" = 1'-0"

## **ELEVATION KEY NOTES**

1 WOOD SHINGLE ROOF 2 METAL ROOF 3 BUILT-UP "CLASS A" ROOF

4 GUTTER / DOV

5 BUILT-UP WOOD E 6 WOOD CEC

7 WOOD TRIM DETA TEAK WINDOW BAY DETAILIN

9 TEAK CORBEL 10 TEAK RAFTER TAILS

11 WOOD ENTRY DOOR 12 WOOD DOOR / WINDOW

13 STEEL DOOR / WINDOW

14 WOOD GARAGE DOOR 15 WOOD GATE

16 WOOD SHUTTER 17 THIN BRICK VENEER

18 CHIMNEY CAP 19 PLANTER WALL - REFER TO LAN

20 DECORATIVE LIGHT FIXTURE 21 DECORATIVE COPPER GABLE VENT

22 BUILDING ADDRESS

23 SKYLIGHT

BUILDING

PROJECT MANAGER: RR PROJECT DESIGNER: BW

PROJECT CAD FILE: 18001-PLN-ELEV

**PICKUP** 

23 Harbor Island

Lot 22, Tract 802

TELEPHONE: FAX:

DRAWN BY: PROJECT NUMBER: 18001

RESIDENCE

Newport Beach, CA 92663

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gans Sweek, CA 12851


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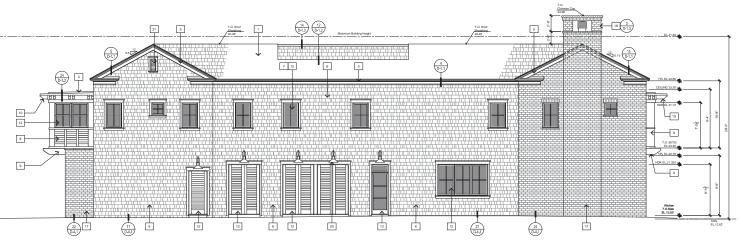
503 32ND STREET, SUITE 130 NEWPORT BEACH, CA 92683 TELEPHONE: (949) 999-3255 FAX: (949) 999-3259 RTINER (ROUP, INC. 2019 ® expressly reserves all common law copyright and property rights in these plans. These plans are not to be reproduced, changed or copied in any form or manner whatsoever, nor are they to be assigned to any third party without first obtaining the express written permission and consent of RTINER GROUP, INC.

ELEVATIONS

A5.1

Left Side Elevation



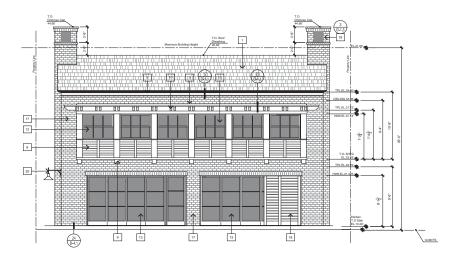

Rear Elevation

Right Side Elevation

### **ELEVATION NOTES**

THE MINIMUM REQUIRED TOP OF SLAB ELEVATION FOR INTERIOR LIVING, AREAS OF ALL NEW STRUCTURES SHALL BE AT LEAST 9.00 (NAVD 88). THE HEIGHT OF A PRINCIPAL STRUCTURE SHALL BE MEASURED FROM TOMINIMUM REQUIRED TOP OF SLAB ELEVATION.

BUILT-UP ROOF (CLASS "A") MODIFIED BITUMEN ROOFING OVER EXTERIOR GRADE ROOF SHEATHING 2% MINIMUM SLOPE U.N.O.

BUILT-UP EAVES, AND RAKES:

GARAGE DOORS & GATES:

CHIMNEY SHALL EXTEND AT LEAST 2'-0' HIGHE THAN ANY PORTION OF THE BUILDING WITHIN 10-0', BUT SHALL NOT BE LESS THAN 3'-0' ABD' THE HIGHEST POINT WHERE THE CHIMNEY

FOUNDATION OF THE CONCRETE PERMETER WALL OF THE FOUNDATION SHALL BE SET AT A MINIMUM ELEVATION OF 2.5 FEET NAVDES TO ACCOMMODATE A POTENTIAL RISE IN SEA LEVEL.

## ELEVATION KEY NOTES

1 WOOD SHINGLE ROOF 2 METAL ROOF

SCALE: 1/4" = 1'-0"

SCALE: 1/4" = 1'-0"

3 BUILT-UP "CLASS A" ROOF 4 GUTTER / DOWN

S BUILT-UP WOOD EAVES

6 WOOD CEDA 7 WOOD TRIM DETAILING

 TEAK WINDOW BAY DETAILING 9 TEAK CORBEL

10 TEAK RAFTER TAILS

11 WOOD ENTRY DOOR 12 WOOD DOOR / WINDOW

13 STEEL DOOR / WINDOW

14 WOOD GARAGE DOOR 15 WOOD GATE

16 WOOD SHUTTER 17 THIN BRICK VENEER F

18 CHIMNEY CAP 19 PLANTER WALL - REFER TO LANDSCAPE PLANS

20 DECORATIVE LIGHT FIXTURE 21 DECORATIVE COPPER GABLE VENT

22 BUILDING ADDRESS 23 SKYLIGHT



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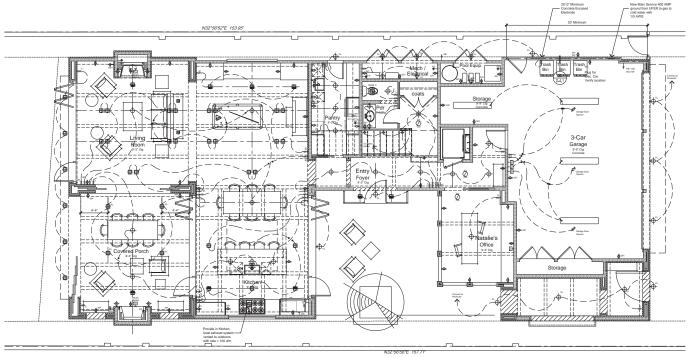
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DRAWN BY: PROJECT NUMBER: 18001
PROJECT CAD FILE: 18001-PLN-ELEV

BUILDING ELEVATIONS

A5.2



First Floor Electrical Plan SCALE: 1/4" = 1'-0"

### ELECTRICAL PLAN NOTES

- APPROVED POOL ALARM OR APPROVED BARRIES PER CITY POOL ORDINANCE.

  1. SC EDION APPROVINLES REQUIRED FOR METER LOCATION DRIVE TO INSTALL ATOM.
- PROVIDE A MINIMUM OF 1-29 AMP LAUNDRY BRANCH CIRCUIT. SUCH CIRCUIT SHALL HAVE NO OTHER OUTLETS. CEC 210-11(C)(2)

- 22. ALL STARS SHALL HAVE AN ILLUMINATION LEVEL ON TREADS RUNS OF NOT LESS THAN 1 FOOT CANDLE (11 kg) CRC 1205.4 23. PROVIDE IN KITCHENS LOCAL EXHAUST SYSTEM VENTED TO OUTDOORS WITH RATE = 100 CFM
  - - 28. ALL EXHAUST FANS SHALL BE CONTROLLED BY A

- 22. ALL NEW HIAC EQUIPMENT MUST MEET APPLICABLE EFFICIENCY REQUIREMENTS IN CSC TABLE 110.2-A THROUGH TABLE 110.2-K

- 43. ALL RECEPTACLES WITHIN REACH SHALL BE TAMPER RESISTANT PER CEC 408.11
- 45. ALL INSTALLED LUMINARIES SHALL SE HIGH-EFFICACY IN ACCORDANCE WITH TABLE 150.0-A PER CEC 150(0)1A.
- IN BATHROOMS, GARAGE, LAUNDRY ROOMS, AND UTILITY ROOMS AT LEAST ONE LIMINAIRE IN EACH OF THESE SPACES SHALL BE CONTROLLED BY A VACANCY SENSOR, CEC. 158:03(U.

## WHOLE BUILDING VENTILATION SYSTEM SUMMARY

- KITCHENS AND BATHROOMS SHALL HAVE LOCAL EXHAUST SYSTEMS VENTED CLOTHES DRYERS SHALL BE VENTED TO THE OUTDOORS.
- VENTILATION AIR SHALL COME FROM OUTDOORS AND SHALL NOT BE TRANSFERRED FROM THE AD. GARAGES OR CRAWL SPACES.
- VENTILATION SYSTEM CONTROLS SHALL BE LABELED AND THE HOME OWNER SHALL BE PROVIDED WITH INSTRUCTIONS ON HIS TO DEPRATE THE SYSTEM.
- THE WALL AND OPENINGS BETWEEN THE HOUSE AND THE GARAGE SHALL BE SEALED.
  HABITABLE ROOMS SHALL HAVE WINDOWS WITH A VETLAXON AREA OF AT LEAST 4% OF THE FLOOR AREA.
- MECHANICAL SYSTEMS INCLUDING HEATING AND AIR CONDITIONING SYSTEMS THAT APPLY AIR TO HABITABLE SPACES SHALL HAVE MERY 6 FILTERS OR BETTER.
- AIR MOVING EQUIPMENT USED TO MEET EITHER THE WHOLE BUILDING VENTILATION REQUIREMENT SHALL BE RATED IN TERMS OF AIRFLOW AND SOUND:
- ALL CONTINUOUSLY OPERATING FAVES SAVEL BE RATED AT A MAXIMUM OF 1.0 SONE.

  INTERNITENTLY OPERATED VANCE BUILDING VENTLATION FAVES SAVEL BE RATED AT A MAXIMUM OF 1.0 SONE.

  INTERNITENTLY OPERATED OLD LOUGHUST FAVE SAVEL BE RATED AT A MAXIMUM OF 3.0 SONE.

  BEWORLY OPERATED ARE MOVING SOLUPBERN BROUNTED OUTSEC OF HARTABLE SPACES NEED TO MEET SOUND

  BEQUIPMENTS OF PROME BAT LEAST A FEET OF DOLUMPS BETWEEN THE ANA DOT THE INTRAC GRIL.

REQUIRED:
HOUSE VENTLATION RATE (c7M) = 4,900 / 100 - 7,5 a 4-1) is clin
40,64 - 7,52 a 44,50 clin
74,64 - 7,52 a 44,50 clin
74,64 - 7,52 a 44,50 clin
74,64 - 7,64





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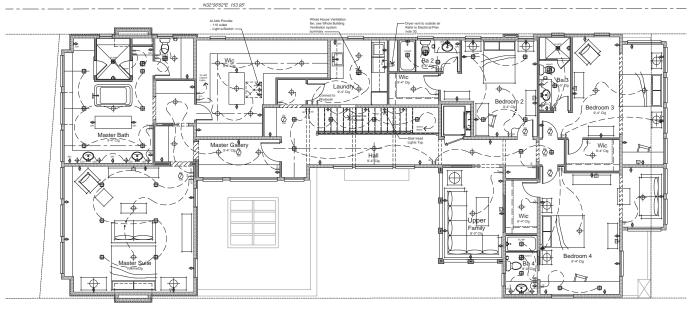
Lot 22, Tract 802

TELEPHONE: FAX:

PROJECT MANAGER: RR PROJECT DESIGNER: BW DRAWN BY: PPO IECT NI IMBER: 18001 PROJECT CAD FILE: 18001-PLN-FLOOR

FIRST FLOOR ELECTRICAL PLAN

A6.1



N32°56'56'E 157.71'

Second Floor Electrical Plan

SCALE: 1/4" = 1'-0"

## ELECTRICAL PLAN NOTES

- APPROVED POOL ALARM OR APPROVED BARRIES PER CITY POOL ORDINANCE.

  1. SC EDION APPROVINLES REQUIRED FOR METER LOCATION DRIVE TO INSTALL ATOM.
- PROVIDE A MINIMUM OF 1-20 AMP LAUNDRY BRANCH CIRCUIT. SUCH CIRCUIT SHALL HAVE NO OTHER OUTLETS. CEC 210-11(C)(2)

- 22. ALL STARS SHALL HAVE AN ILLUMINATION LEVEL ON TREADS RUNS OF NOT LESS THAN 1 FOOT CANDLE (11 kg) CRC 1205.4
- 23. PROVIDE IN KITCHENS LOCAL EXHAUST SYSTEM VENTED TO OUTDOORS WITH RATE = 100 CFM SMOKE DETECTORS ARE NOT TO BE LOCATED IN KITCHEN, GARAGE, OR WITHIN 3 FEET FROM DOOR TO KITCHEN OR BATHROOM OR SUPPLY AND DEGISTEDS
  - - 28. ALL EXHAUST FANS SHALL BE CONTROLLED BY A HUMBOSTAT.
- 22. ALL NEW HIAC EQUIPMENT MUST MEET APPLICABLE EFFICIENCY REQUIREMENTS IN CSC TABLE 110.2-A THROUGH TABLE 110.2-K

- 43. ALL RECEPTACLES WITHIN REACH SHALL BE TAMPER RESISTANT PER CEC 408.11
- 45. ALL INSTALLED LUMINARIES SHALL SE HIGH-EFFICACY IN ACCORDANCE WITH TABLE 150.0-A PER CEC 150(0)1A.
- IN BATHROOMS, GARAGE, LAUNDRY ROOMS, AND UTILITY ROOMS AT LEAST ONE LIMINAIRE IN EACH OF THESE SPACES SHALL BE CONTROLLED BY A VACANCY SENSOR, CEC. 158:03(U.

## WHOLE BUILDING VENTILATION SYSTEM SUMMARY

- KITCHENS AND BATHROOMS SHALL HAVE LOCAL EXHAUST SYSTEMS VENTED TO
   CLOTHES DRYERS SHALL BE VENTED TO THE OUTDOORS.
- VENTILATION AIR SHALL COME FROM OUTDOORS AND SHALL NOT BE TRANSFERRED FROM THE ADJACENT DWELLING UNITS GARAGES OR CRAWL SPACES.
- VENTILATION SYSTEM CONTROLS SHALL BE LABELED AND THE HOME OWNER SHALL BE PROVIDED WITH INSTRUCTIONS ON HOW TO OPERATE THE SYSTEM.
- THE WALL AND OPENINGS BETWEEN THE HOUSE AND THE GRAPACE SHALL BE SEALED.

  HABITABLE ROOMS SHALL HAVE WINDOWS WITH A VETLADON AREA OF AT LEAST 4% OF THE FLOOR AREA.
- MECHANICAL SYSTEMS INCLUDING HEATING AND AIR CONDITIONING SYSTEMS THAT APPLY AIR TO HABITABLE SPACES SHALL HAVE MERY OF FILTERS OR BETTER.
- AIR MOVING EQUIPMENT USED TO MEET EITHER THE WHOLE BUILDING VENTILATION REQUIREMENTS OR THE LOCAL EXHAUST REQUIREMENT SHALL BE RATED IN TERMS OF ARPLOW AND SOLIND:
- A. ALL CONTRUCUELY OPERATING FANS SHALL BE RATED AT A MAXIMAM OF 10 SOME.

  B. INTERNITIONITY OPERATE DOWNER BUILDING WINTLANDIN FANS SHALL BE RATED AT A MAXIMAM OF 10 SOME.

  C. INTERNITIONITY OPERATED DOLD EMPLOYED FANS SHALL BE RATED AT A MAXIMAM OF 10 SOME.

  D. BEODITY OPERATED DATA ADVINCE DOLDHOST FANS SHALL BE RATED AT A MAXIMAM OF 10 SOME.

  D. BEODITY OPERATED ARRADINAL EQUIPMENT ANDIANTED CUITSDE OF IMMETABLE SPACES NEED TO MEET SOUND REQUIPMENTS IF THERE STATE AT SETS OF THE TOWN RETHROUGH THE ANA ADD THE INTRACE GREL.
- A MINIMUM INTERMITTENT VENTILATION AIRFLOW OF 100 CPM IS REQUIRED FOR THE KITCHEN RANGE HOOD INTERMITTENT VENTILATION AIRFLOW OF 50 CPM IS REQUIRED FOR THE BATH FAX.

REQUIRED.

NOISE VENT-LATION RATE (CTM) = 4,999 / 100 = 7,5 x.4-f) = cfm.

THEREFORE, PROVIDE (1) BROAN OBTAINED (50 APPROVED EQUAL: 50 CFM © .025" - 6" DIA, FLEXBLE METAL DUCT WITH A MAXIMAN LENGTH OF 125' MINUS 15" FOR EACH FLEDON.





## rither GROUP

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# PICKUP **RESIDENCE**


23 Harbor Island Newport Beach, CA 92663

TELEPHONE: FAX:

PROJECT MANAGER: RR PROJECT DESIGNER: BW DRAWN BY: PPO IECT NI IMBER: 18001 PROJECT CAD FILE: 18001-PLN-FLOOR

SECOND FLOOR ELECTRICAL PLAN

A6.2

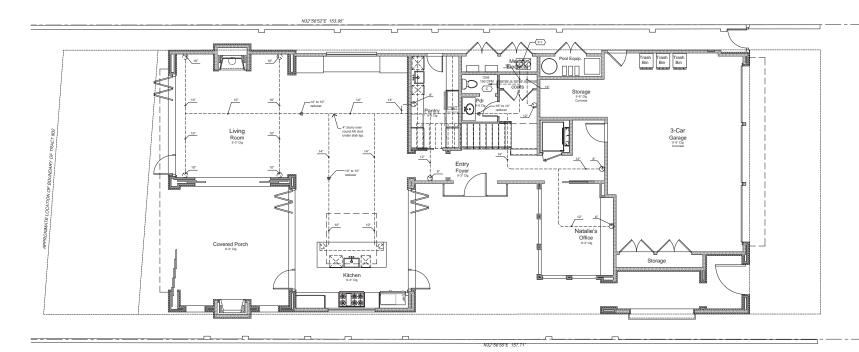

First Floor Mechanical Plan SCALE: 1/4" = 1'-0"

## Note

## EQUIPMENT LIST

- F-2 AIR HANDLER (2) LENNOX MMDA024S4 2 TON DUCTED MINI SPLIT INDOOR UNIT
- HP-1 HEAT PUMP LENNOX MPBO48S4M 4 TON 17 SEER 230 / 1ph, 50 amps, 64 dba
- T-2 THERMOSTAT HONEYWELL T6-PRO PROGRAMMABLE
- (EF-1)

- 15 FOR EACH ELBOW.

  A STEEL STAMPED FACE SUPPLY AIR DIFFUSER/REGISTER SUZE AND SHAPE TO BE DETERMINED.

  B STEEL STAMPED FACE SIDEWALL SUPPLY AIR DIFFUSER/REGISTER SUZE AND SHAPE TO BE DETERMINED.

  C DEFUSER/REGISTER SUZE AND SHAPE TO BE DETERMINED.

  STEEL STAMPED FACE FLOOR SUPPLY AIR DIFFUSER/REGISTER SUZE AND SHAPE TO BE DETERMINED.

SINCRE / CARBON MONORIDE DETECTOR
UL 2014/2015 ALARRIS

### MECHANICAL PLAN NOTES

- ALL BATHROOM FANS TO BE 50 CFM'S MINIMUM. PROVIDE A MINIMUM OF FIVE (5) AIR CHANGES PER HOUR. A MAXIMUM SOUND RATING OF 3 SON FOR INTERMITTENT OPERATION, BE LISTED AS BE STATE RATED AND CONTROLLED BY A HUMINIDIT CONTROL UNLESS EXEMPTED ELSEWHERE.
- SMOKE DETECTORS AND CARBON MONOXIDE ALARM IN ACCORDANCE WITH SECTION R315.1 SHALL BE INSTALLED AS FOLLOWS:
  - A WHERE MORE THAN SMOKE DECTECTOR / CARBON MONOXIDE ALARM IS REQUIRED TO BE INSTALLED WITHIN THE DIVIDING TOR WITHIN A SLEEPING UNIT THE ALARM SHALL BE INTERCONNECTED IN A MANNER THAT ACTIVATION OF ONE ALARM SHALL ACTIVATE ALL OF THE ALARMS IN THE NOIVIDIDAL UNIT.
  - B. SMOKE DETECTORS / CARBON MONOXIDE ALARMS SHALL RECEIVE THEIR PRIMARY
- ALL R-6 FLEX DUCT AND RECTANGULAR AS NEEDE PER PLAN WRAPPED TO R6 INSULATION VALUES.

## MECHANICAL LEGEND

## WHOLE BUILDING VENTILATION SYSTEM SUMMARY

ALL LOW-RISE RESIDENTIAL BUILDING ARE REQUIRED TO HAVE A VENTILATION SYSTEM AND SATISFY OTHER REQUIREMENT TO ACHIEVE ACCEPTABLE INDOOR ARE QUALITY (AND, THE EMERGY COMMISSION ACCEPTED THE REQUIREMENTS OF ASHRAE STRANGAME 2.5 DOOD, EXCEPT THAT OFENING AND LOSION WINDOODS A LITHOUGH PERMITTED BY ASHRAED, IN NOT AN

- A WHICE BULDING MECHANICAL VENTELATION SYSTEM SHALL BE PROVINCE.

  KITCHEN AS DIA PRIRODOMS SHALL NIVE LOCAL EXPORTS SYSTEMS VENTED TO CLOTHES DRIVERS SHALL BE VENTED TO THE OUTDOORS.

  VENTELATION ARE SHALL COME FROM OUTDOORS AND SHALL NOT BE TRANSFER GRANGES OR CHANGES OR CH
- VENTILATION SYSTEM CONTROLS SHALL BE LABELED AND THE HOME OT OPERATE THE SYSTEM.
- THE WALL AND OPENINGS BETWEEN THE HOUSE AND THE GARAGE SHALL BE SEALED.

- AR MOVING EQUIPMENT USED TO MEET EITHER THE WHOLE BUILDING VENTILATION REC EXHAUST REQUIREMENT SHALL BE RATED IN TERMS OF AIRFLOW AND SOUND:
- A MINIMUM INTERMITTENT VENTILATION ARFLOW OF 100 CFM IS REQUIRED FOR THE KI INTERMITTENT VENTILATION ARFLOW OF 50 CFM IS REQUIRED FOR THE BATH FAN.

CONTINUOUS VENTILATION CALCULATION: (MIN. AIRFLOW MEASURED (8 0.25' FOR C (CFA / 100) + 7.5 (# OF BEDROOMS + 1) = VENTILATION RATE (MINIMUM CFM (8 0.25')

REQUIRED: HOUSE VENTILATION RATE (CFM) = 4,999 / 100 + 7.5 x 4+1) = cfm 49.09 + 37.5 = 96.59 cfm

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# PICKUP RESIDENCE

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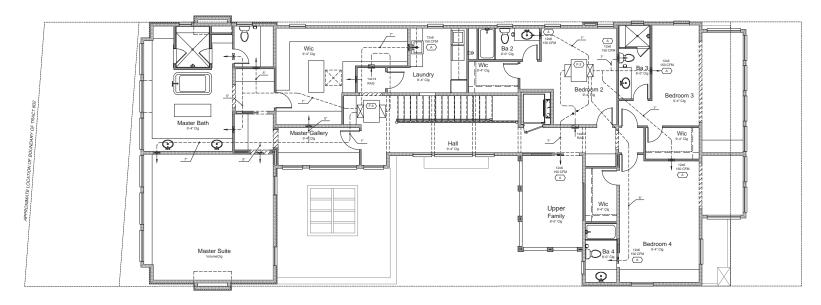
PROJECT MANAGER: RR PROJECT DESIGNER: BW

DRAWN BY: PPO IECT NI IMBER: 18001 PROJECT CAD FILE: 18001-PLN-FLOOR

FIRST FLOOR MECHANICAL

PLAN

A7.1



N32°56'56"E 157.71"

Second Floor Mechanical Plan SCALE: 1/4" = 1'-0"

### Note

## EQUIPMENT LIST

- F-2 AIR HANDLER (2) LENNOX MMDA024S4 2 TON DUCTED MINI SPLIT INDOOR UNIT HP-1 HEAT PUMP - LENNOX MPBO48S4M 4 TON 17 SEER 230 / 1ph, 50 amps, 64 dba
- T-2 THERMOSTAT HONEYWELL T6-PRO PROGRAMMABLE
- (EF-1)

- 15 FOR EACH ELBOW.

  A STEEL STAMPED FACE SUPPLY AIR DIFFUSER/REGISTER SIZE AND SHAPE TO BE DETERMINED.

  B STEEL STAMPED FACE SIDEWALL SUPPLY AIR DIFFUSER/REGISTER, SUZE AND SHAPE TO BE DETERMINED.

  C DEFUSER/REGISTER, SUZE AND SHAPE TO BE DETERMINED.

  STEEL STAMPED FACE FLOOR SUPPLY AIR.

  DEFUSER/REGISTER, SUZE AND SHAPE TO BE DETERMINED.

### MECHANICAL PLAN NOTES

- ALL BATHROOM FANS TO BE 50 CFM'S MINIMUM.
  PROVIDE & MINIMUM OF FIVE (5) AIR CHANGES
  PER HOLE. A MAXIMUM SOUND RATING OF 3 SON
  FOR INTERMITTENT OPERATION, BE LISTED AS ENSTATE BATED AND CONTROLLED BY A HUMMOITY
  CONTROL UNLESS EXEMPTED ELSEWHERE.
- - A WHERE MORE THAN SMOKE DECTECTOR / CARBON MONOXIDE ALARM IS REQUIRED TO BE INSTALLED WITHIN THE DIVIDING TOR WITHIN A SLEEPING UNIT THE ALARM SHALL BE INTERCONNECTED IN A MANNER THAT ACTIVATION OF ONE ALARM SHALL ACTIVATE ALL OF THE ALARMS IN THE NOIVIDIDAL UNIT.
  - B. SMOKE DETECTORS / CARBON MONOXIDE ALARMS SHALL RECEIVE THEIR PRIMARY
- ALL R-6 FLEX DUCT AND RECTANGULAR AS NEEDED
   PER PLAN WRAPPED TO R6 INSULATION VALUES.

## MECHANICAL LEGEND

SINCRE / CARBON MONORIDE DETECTOR
UL 2014/2015 ALARRIS

--- nound plot under ricon reviews

### WHOLE BUILDING VENTILATION SYSTEM SUMMARY

ALL LOW-PISE RESIDENTIAL BUILDING ARE REQUIRED TO HAVE A VENTILATION SYSTEM AND SATISFY OTHER REQUIREMENTS TO ACHIEVE ACCEPTABLE INDOOR ARE QUALITY (MIQ. THE INERROY COMMISSION ACCOPTED THE REQUIREMENTS OF ASSPACE STRANGAMED 2-3000, EXCEPT THAT OFENING AND COLOMIN MINIORING A HYDIOL REPRINTED BY ASSPACE STRANGAMED 2-3000, EXCEPT THAT OFENING AND COLOMIN MINIORING A HYDIOL REPRINTED BY ASSPACE STRANGAMED 2-300, EXCEPT THAT OFENING AND COLOMIN MINIORING A HYDIOL REPRINTED BY ASSPACE STRANGAMED 2-300, EXCEPT THAT OFENING AND COLOMIN MINIORING AND HYDIOLOGY.

- A WHICE BULDING MECHANICAL VENTLATION SYSTEM SHALL BE PROVIDED.

  KITCHENS AND ASTROPOODES SHALL HAVE LOCAL EXPORTS SYSTEMS VENTED TO THE OIL

  CLOTHES DRIVERS SHALL BE VENTED TO THE OUTDOORS.

  VENTLATION ARE SHALL COME FROM OUTDOORS AND SHALL NOT BE TRANSFERRED FR
  GRANGES OR CRAWN, SPACES.
- VENTILATION SYSTEM CONTROLS SHALL BE LABELED AND THE HOME OWNE TO OPERATE THE SYSTEM.

- COMBUSTION APPLIANCES SHALL BE PROPERLY VENTED AND ARE SYSTEMS SHALL BE DESIGNED TO PRE
  THE WALL AND COMMISSION SETTINGS THE HOUSE AND THE GARACE SHALL BE STATE
  HABITABLE ROOMS SHALL HAVE WINDOWS WITH A VETLACION AREA OF AT LEAST HY, OF THE FLOOR AREA
  MICHARCAL SYSTEMS INCLIDING HEATING AND AIR CONCITIONING SYSTEMS THAT APPLY AIR TO HABIT
  HAVE MIXEN OF ATTERS OR BETTER.
- AR MOVING EQUIPMENT USED TO MEET EITHER THE WHOLE BUILDING VENTILATION REQUESTABLET REQUIREMENT SHALL BE RATED IN TERMS OF AIRFLOW AND SOUND:
- ALL CONTINUOUSLY OPERATING FARS SHALL BE RATED AT A MAXIMUM OF 1.0 SONE.

  INTERPRETENTLY OPERATIO WHOLE BUILDING VENTILATION FARS SHALL BE RATED AT A MAXIMUM OF 1.0 SONE.

  REMOTELY OPERATED CARE CHARMEST FARS SHALL BE RATED AT A MAXIMUM OF 3.0 SONE.

  REMOTELY OPERATED ARE MOVING EQUIPMENT MICHAEL OF A TOTAL OF HER TABLE SPACES, NEED TO MEET SOUR

  REMOTELY OPERATED ARE MOVING EQUIPMENT MICHAEL OF THE PARK ADTHE IN THAT GEGILL.
- A MINIMUM INTERMITTENT VENTILATION AIRFLOW OF 100 CFM IS REQUIRED FOR THE INTCHES INTERMITTENT VENTILATION AIRFLOW OF 50 CFM IS REQUIRED FOR THE BATH FAN.

CONTINUOUS VENTILATION CALCULATION: (MIN. AIRFLOW MEASURED @ 0.25' FOR CO (CFA / 100) + 7.5 (# OF BEDROOMS + 1) = VENTILATION RATE (MINIMUM CFM @ 0.25')

REQUIRED: HOUSE VENTILATION RATE (CFM) = 4,999 / 100 + 7.5 x 4+1) = cfm 49.09 + 37.5 = 96.59 cfm

ForestStudio spens Street, SA 12651

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# PICKUP RESIDENCE

23 Harbor Island Newport Beach, CA 92663

Lot 22, Tract 802

TELEPHONE: FAX:


PROJECT MANAGER: RR PROJECT DESIGNER: BW

DRAWN BY: PPO IECT NI IMBER: 18001 PROJECT CAD FILE: 18001-PLN-FLOOR

SECOND FLOOR MECHANICAL

PLAN

A7.2

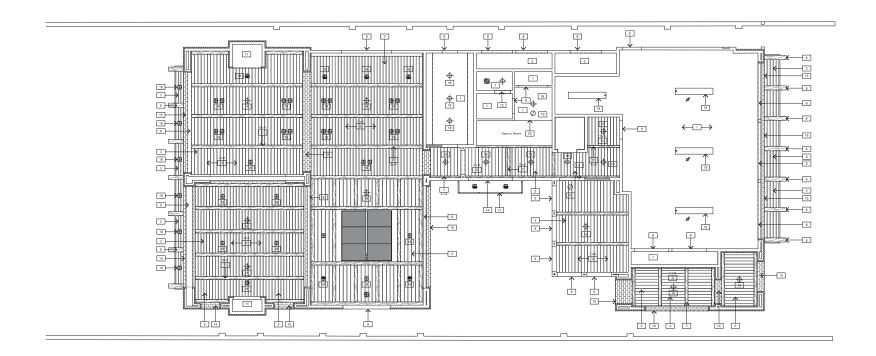

First Floor Reflected Ceiling Plan

## REFLECTED CEILING PLAN KEY NOTES







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Lot 22, Tract 802

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PROJECT MANAGER: RR
PROJECT DESIGNER: BW
DRAWN BY:


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PROJECT NUMBER: 18001
PROJECT CAD FILE: 18001-PLN-FLOOR

SHEET TITLE:

FIRST FLOOR REFLECTED CEILING PLAN

OUEET NI IMBED

A8.1

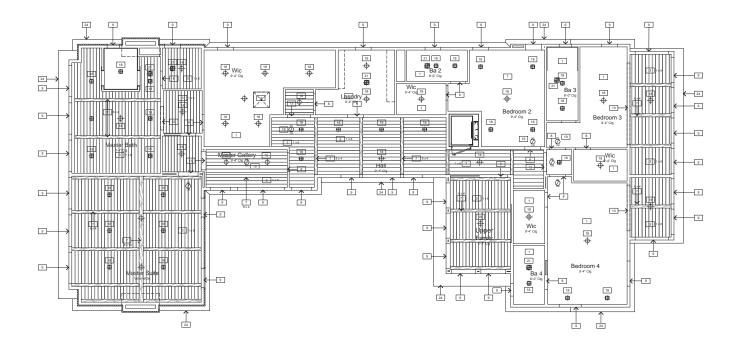

Second Floor Reflected Ceiling Plan SCALE: 1/4" = 1'-0"

### REFLECTED CEILING PLAN KEY NOTES

XX	SYMBOL			
1	DRYWALL CEILING	16	ATTIC ACCESS	
2	PLASTER FINISH CEILING	17	BAY WINDOW	
3	T&G SHEATHING	18	LIGHT FIXTURE REFER TO ELECTRICAL PLANS	
4	T&G ROOF SHEATHING	19	SMOKE DETECTOR REFER TO ELECTRICAL PLANS	
5	EXPOSED RAFTER TAIL	19		
6	EXPOSED BEAMS AND RAFTERS	20	MECHANICAL REGISTER REFER TO MECHANICAL PLANS	
7	APPLIED WOOD BEAM			
8	DOOR OPENING	21	MECHANICAL FAN REFER TO MECHANICAL	
9	WINDOW OPENING	22	LINE OF FLOOR ABOVE	
10	GARAGE DOOR OPENING	23	LINE OF FIREPLACE ABOVE	
11	FIREPLACE OPENING	24	LINE OF ROOF ABOVE	
12	DRYWALL OPENING	25	LINE OF BALCONY RAIL	
13	CASED OPENING	26	PLASTER SOFFIT	
14	PLASTER OPENING	27	LINE OF FACE FRAME CABINET	
15	BRICK VENEER OPENING	28	RECESSED CEILING MOUNTED	





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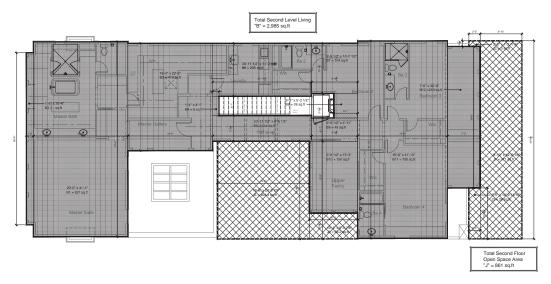
TELEPHONE:

PROJECT MANAGER: RR PROJECT DESIGNER: BW


DRAWN BY:
PROJECT NUMBER: 18001
PROJECT CAD FILE: 18001-PLN-FLOOR

SECOND FLOOR REFLECTED CEILING PLAN

A8.2



Second Level - Overlay Plan

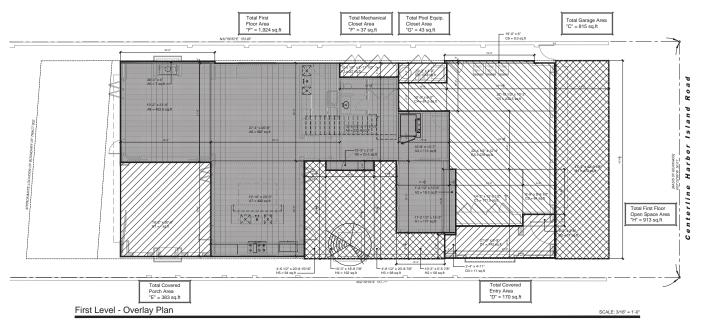

## Zoning Requirements 4,485 Sq. Ft. Floor Area Limit: 8,970 Sq. Ft. Proposed Floor Area: 6.357 Sq. Ft. Required Open Space: (4,485 Sq. Ft. x 15%) 673 Sq. Ft. 1,774 Sq. Ft. 20' x 28'-3" Area Tabulations 5,462 Sq. Ft. 815 Sq. Ft. 37 Sq. Ft. 43 Sq. Ft. Proposed Building Area Total (Livable): Garage / Mechanical: 5,462 Sq. Ft. 895 Sq. Ft.

Allowable Building Area:

6.357 Sq. Ft.

8,970 Sq. Ft.

A1:	"abulation 171 Sq. Ft.	F1:	37 Sq. F
A2-	18.5 Sq. Ft		o. eq
A3:	114 Sq. Ft. 221.6 Sq. Ft.	Total Mechanical Closet	
A4: A5:	221.6 Sq. Ft.	Area:	37 Sq. F
A6:	20.5 Sq. Ft. 567 Sq. Ft.		
A7:	402 Sq. Ft.	G1:	43 Sq. F
A8: A9:	402.5 Sq. Ft. 7 Sq. Ft.	Total Pool Equipment	
Total First Floor Livin	g	Closet Area:	43 Sq. F
Area:	1,924 Sq. Ft.	H1:	473 Sq. I
B1:	22 Sq. Ft.	H2:	56 Sci 1
B2:	109 Sq. Ft.	H3: H4:	98 Sq. I 192 Sq. I
B3:	35 Sq. Ft.	HS:	192 Sq. I 94 Sq. I
B4:	9 Sri Ft	no.	94 SQ. I
B5:		Total First Floor	
B6: B7:	251 Sq. Ft. 251 Sq. Ft.	Open Space Area:	913 Sq. I
B/: RR:	251 Sq. Ft. 251 Sq. Ft.		
B9:	251 Sq. Ft.	J1:	371 Sq. F
B9:	251 Sq. Ft.	J2:	3 Sa. F
B10:	251 Sq. Ft. 251 Sq. Ft.	J3:	26 Sq. F
B11: B12:	251 Sq. Ft. 251 Sq. Ft.	J4:	26 Sq. F 56.2 Sq. F
Total Second Floor Li		J5:	404.4 Sq. I
Area:	2,985 Sq. Ft.	Total Second Floor Open Space Area:	861 Sq. I
C1: C2: C3:	171.5 Sq. Ft.		
C2:	64 Sq. Ft.		
C3:	276 Sq. Ft.		
C4: C5:	61.5 Sq. Ft. 232.5 Sq. Ft.		
C6:	9.5 Sq. Ft.		
Total Garage			
Area:	815 Sq. Ft.		
D1:	142 Sq. Ft. 17 Sq. Ft.		
D2: D3:	17 Sq. Ft. 11 Sq. Ft.		
Total Covered Entry			
Area:	170 Sq. Ft.		
E1:	383 Sq. Ft.		
Total Covered Porch Area:	383 Sq. Ft.		
Hatching Lege	end		
IIIIIIIIIIIIIIIIIIIIIIIIIIIIIIIIIIII			
IIIIIIIII	Hatching Indicates Garage		
	Garage		
777777	Hatching Indicates		
	Covered Entry,		
V//////	Covered Porch,		
<i>V//////</i>	Mech closet and		
	Pool Equip. closet		
x	Matchine Indicates		
	Hatching Indicates		
	Hatching Indicates Open Space Area		

A -	



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Lot 22, Tract 802

TELEPHONE:

PROJECT MANAGER: RR PROJECT DESIGNER: BW DRAWN BY:
PROJECT NUMBER: 18001
PROJECT CAD FILE: 18001-PLN-FLOOR-OVERLA

OVERLAY PLANS

A9.1

ForestStudio on Bunch, 24 12651 rither GROUP 503 32ND STREET, SUITE 130 TELEPHONE: (949) 999-3255 FAX: (949) 999-3259





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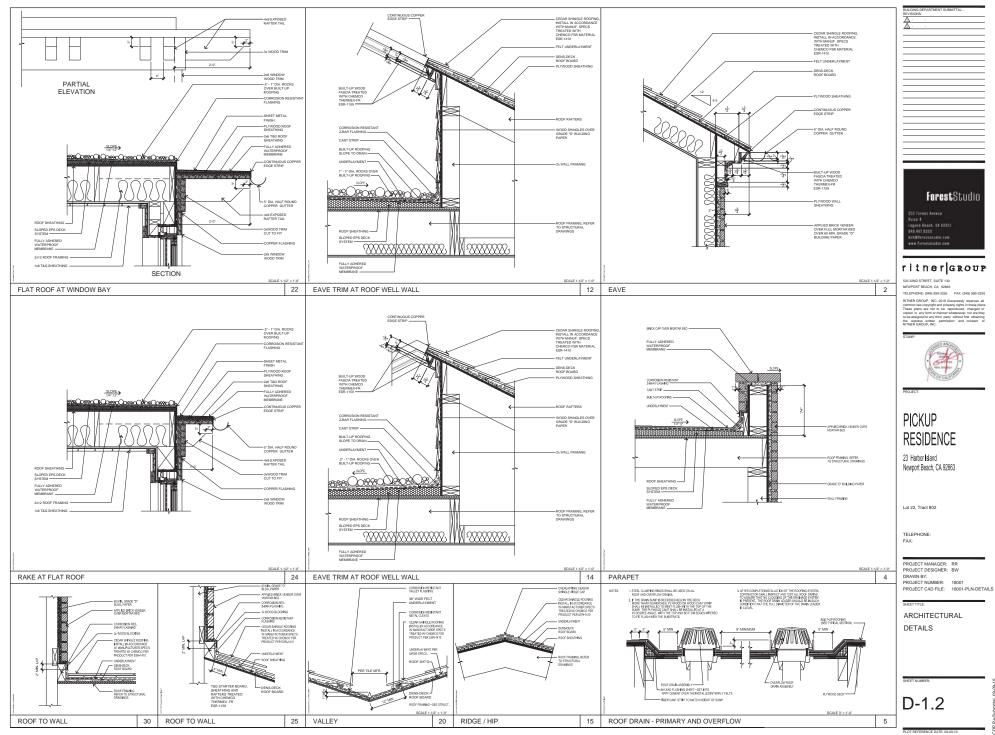
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TELEPHONE:


PROJECT MANAGER: RR PROJECT DESIGNER: BW DRAWN BY: PROJECT NUMBER: 18001
PROJECT CAD FILE: 18001-PLN-DETAILS

ARCHITECTURAL DETAILS

D-1.1



ForestStudio

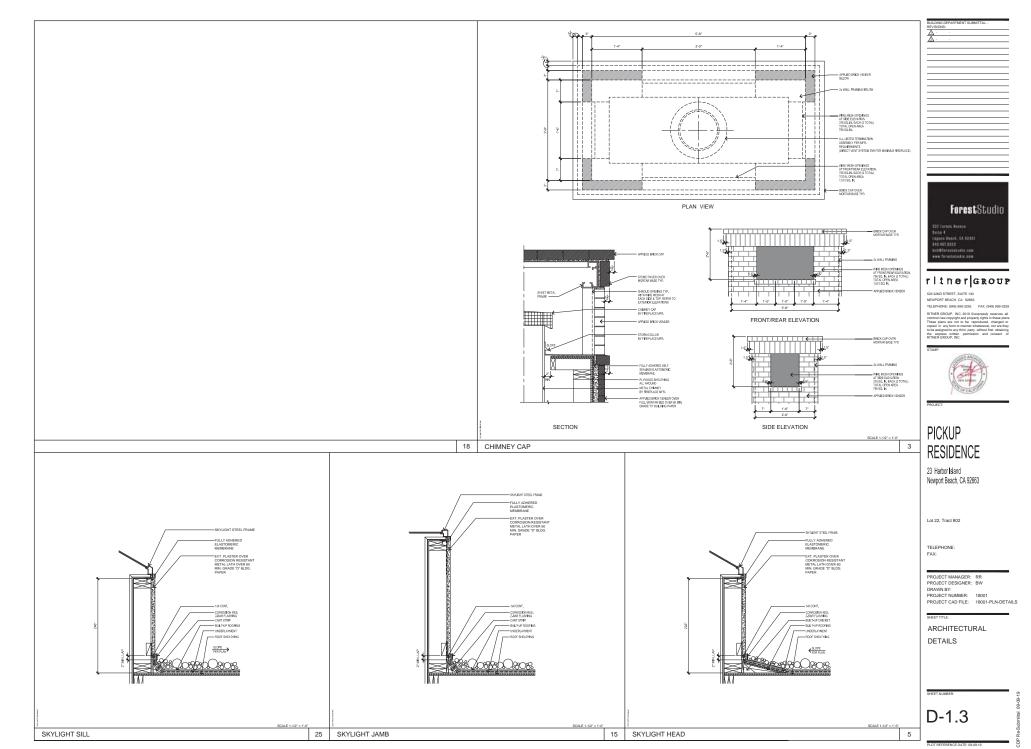

20 DOOR THRESHOLD

15

DOOR THRESHOLD

10


STEEL DOOR THRESHOLD

O.2018-PROJECTS/98001/CD/18001-PLN-DETALS September 9, 2019

30

25

5

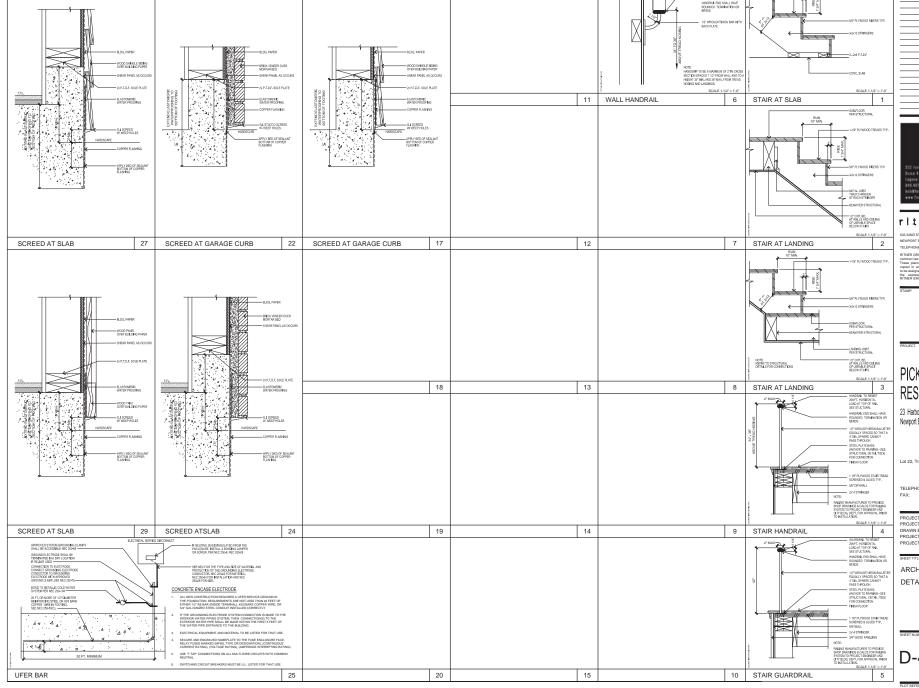

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